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REVISIONS

04/17/24 SB 330 APPLICATION

REVISION CHANGE

04/17/24 SB 330 APPLICATION

APPLICANT Ruben, Junius & Rose, LLP 1 Bush St. Ste. 600 San Francisco, CA 94104

PROJECT NAME 1965 Market St

San Francisco, CA 94103

BLOCK/LOT 3534 / 058, 059, 061 & 062

SCALE AS NOTED **DRAWN BY** TG / MP / SP

CHECKED BY

PROJECT NO. 202314

DATE OF PUBLICATION 4/18/24

COVER SHEET

DRAWING NO. 1 OF 24

1965 Market St, San Francisco

AREA DRAIN

APPROXIMATE

ASPHALT

BUILDING

CEILING

DOUBLE

DIMENSION

DISPOSER

DRAWING

DRAWER

ELEVATION

ELECTRICAL

FLOOR DRAIN

FOUNDATION

FACE OF

GALIGE

HOSE BIB

HEADER

HARDWARE

HORIZONTAL

INSULATION

INTERIOR

LAVATOR\

MASTER

MAXIMUM

MECHANICA

MECHANICAL /

MANUFACTURER

ELECTRIC/PLUMBING

DEMO WALL (PLAN VIEW)

NEW WALL (PLAN VIEW)

HIDDEN EDGE, ABOVE OR

HIDDEN EDGE, BELOW OR

CENTER OF STEEL U.O.N.

FACE OF STUD, CONCRETE OR

HATCH = STRUCTURE

OUTLINE = FINISH

FACE OF FINISH

DOOR SYMBOL

WINDOW SYMBOI

= WINDOW TYPE LETTER = OITC RATING

SKYLIGHT SYMBOL

WALL (FLOOR) TYPE

SECTION MARKER:

ELEVATION MARKER:

ROOM NO O/

MATERIAL CODE

SPOT ELEVATION

PROPERTY LINE

ELECTRICAL/ MECHANICAL SYMBOLS

DRAWING # O/ SHEET #

FLOOR | WALL | CEILING

NEW OR FINISHED CONTOURS

EXISTING CONTOURS

SURFACE CELLING

RECESSED DIRECTIONAL

WALL MOUNTED LIGHT FIXTURE

PHOTOCONTROL LIGHT FIXTURE

RECESSED WALL LIGHT FIXTURE

CONCEALED STRIP LIGHT

TRACK AND STRIP

ELECTRICAL SWITCH

LIGHT FIXTURES

3-WAY SWITCH

4-WAY SWITCH

DIMMER SWITCH

MANUAL-ON OCCUPANCY SENSOR SWITCH

PULL SWITCH

EXPOSED STRIP LIGHT FIXTURE

LIGHT FIXTURE

LIGHT FIXTURE

RECESSED CEILING

MOTION DETECTOR &

LEVEL LINE OR DATUM

GRID OR REFERENCE LINE

DRAWING # O/ SHEET #

GUARD SYMBOL

EXISTING WALL (PLAN VIEW)

JOINT

INSIDE DIAMETER

INSULATED GLASS

GALVANIZED

GYPSUM BOARD

F.O.S.

F.S.M.F

GYP. BD

HDWR

HORIZ

MISC.

_ _ _

W(F)##

A B C

+100.0'

- -- ----

 \leftarrow

FLUOR

REFERENCE SYMBOLS

FINISHED FLOOR

FACE OF FINISH

FACE OF STUD

FLEXIBLE SHEET

MEMBRANE FLASHING

DOWN

BLOCKING BUILT-UP ROOFING


ARCHITECTURAL

CONTROL JOINT

CEILING HEIGHT

CONTINUOUS

ABOVE FINISH FLOOR

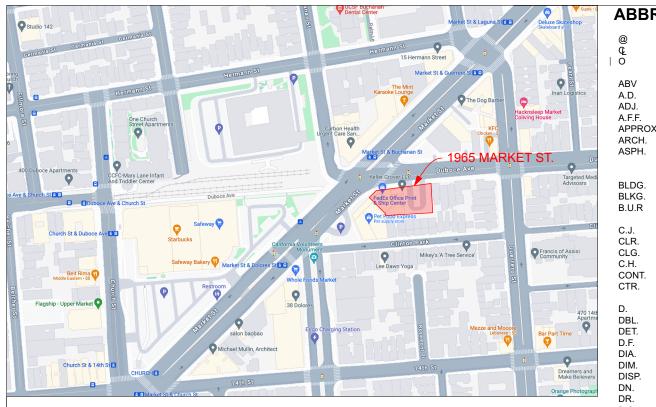

VICINITY MAP

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M.E.P. ENGINEER

CIVIL ENGINEER

GENERAL NOTES

- 01 CODES: ALL WORK SHALL CONFORM WITH OR EXCEED THE REQUIREMENTS OF CURRENT APPLICABLE CITY COUNTY AND STATE CODES, AND ALL OTHER APPLICABLE, CODES. ORDINANCES AND REGULATIONS INCLUDING BUT NOT LIMITED TO FIRE DEPARTMENT REGULATIONS, UTILITY COMPANY REQUIREMENTS, AND THE BEST TRADE PRACTICES. SEE CODE EDITIONS ON THIS SHEET.
- 02 PERMITS: BEFORE COMMENCING WORK, THE CONTRACTOR SHALL FILE ALL REQUIRED CERTIFICATES OF INSURANCE WITH THE DEPARTMENT OF BUILDING INSPECTIONS, OBTAIN ALL REQUIRED PERMITS, AND PAY ALL FEES REQUIRED BY GOVERNING AGENCIES.
- 03 EXISTING CONDITIONS AND DIMENSIONS: THE CONTRACTOR SHALL VERIFY ALL EXISTING CONDITIONS IN THE FIELD PRIOR TO COMMENCING WORK, AND SHALL REPORT ANY DISCREPANCIES BETWEEN DRAWINGS AND FIELD CONDITIONS TO THE ARCHITECT. CALLED-OFF DIMENSIONS SHALL TAKE PRECEDENCE OVER SCALED-OFF DIMENSIONS. DIMENSIONS ARE TO FACE OF STRUCTURE (STUD, CONCRETE, STEEL), UNLESS OTHERWISE NOTED. DIMENSIONS IN SECTIONS AND ELEVATIONS ARE TO TOP OF PLATE OR TOP OF SUB-PLATE UNLESS OTHERWISE NOTED. ELEVATION MARKERS ARE TO TOP OF FINISHED FLOORS
- 04 PLANS & SPECIFICATIONS: THE PLANS AND SPECIFICATIONS SUPPLEMENT EACH OTHER. CONTRACTOR TO IMMEDIATELY REPORT ANY ERRORS, OMISSIONS, AMBIGUITIES OR CONFLICTS IN THE PLANS AND SPECIFICATIONS TO THE ARCHITECT, AND UNTIL THEY ARE RESOLVED, SHALL NOT PROCEED WITH THE AFFECTED WORK
- 05 DETAILS: DETAILS SHOWN ARE TYPICAL. SIMILAR DETAILS SHALL APPLY IN SIMILAR CONDITIONS. MINOR DETAILS NOT USUALLY SHOWN OR SPECIFIED, BUT NECESSARY FOR PROPER CONSTRUCTION OF ANY PART OF THE WORK SHALL BE INCLUDED AS IF THEY WERE INDICATED
- 06 COORDINATION: THE CONTRACTOR SHALL COORDINATE ALL WORK PROCEDURES WITH REQUIREMENTS OF LOCAL AUTHORITIES AND BUILDING MANAGEMENT
- 07 CONTRACTOR RESPONSIBILITY: THE CONTRACTOR SHALL BE RESPONSIBLE FOR THE MEANS. METHODS, TECHNIQUES AND SEQUENCES OF CONSTRUCTION AND SHALL BE RESPONSIBLE FOR THE PROTECTION OF ALL CONDITIONS AND MATERIALS WITHIN THE PROPOSED CONSTRUCTION AREA. THE CONTRACTOR SHALL DESIGN AND INSTALL ADEQUATE SHORING AND BRACING FOR ALL STRUCTURAL OR REMOVAL TASKS UNTIL THE NEW PERMANENT STRUCTURE CAN PROVIDE ADEQUATE VERTICAL AND LATERAL SUPPORT. THE CONTRACTOR SHALL HAVE SOLE RESPONSIBILITY FOR ANY DAMAGE OR INJURIES CAUSED BY OR DURING THE EXECUTION OF THE WORK.
- 08 INSTALLATION: THE CONTRACTOR SHALL LAY OUT HIS OWN WORK, AND SHALL PROVIDE ALL DIMENSIONS REQUIRED FOR OTHER TRADES (PLUMBING, ELECTRICAL, ETC.). ALL MATERIALS AND EQUIPMENT SHALL BE INSTALLED IN STRICT ACCORDANCE WITH THE MANUFACTURER'S PRINTED INSTRUCTIONS OR RECOMMENDATIONS, UNLESS AGREED TO OTHERWISE BY THE
- 09 SUBCONTRACTORS: PLUMBING AND ELECTRICAL WORK SHALL BE PERFORMED BY PERSONS LICENSED IN THEIR TRADES, WHO SHALL ARRANGE FOR AND OBTAIN INSPECTIONS AND
- 10 REPAIR: THE CONTRACTOR SHALL DO ALL CUTTING, PATCHING, REPAIRING AS REQUIRED TO PERFORM ALL OF THE WORK INDICATED ON THE DRAWINGS, AND ALL OTHER WORK THAT MAY
- 11 ABANDONMENT: ALL PIPING AND WIRING SHALL BE REMOVED TO A POINT OF CONCEALMENT AND SHALL BE PROPERLY CAPPED OR PLUGGED
- 12 CLOSE-OUT: THE CONTRACTOR, UPON COMPLETION OF THE WORK, SHALL ARRANGE FOR DEPARTMENT OF BUILDINGS INSPECTIONS AND SIGN-OFFS AS REQUIRED
- 13 UPON COMPLETION OF BUILDING CONSTRUCTION AN ERRC TEST SHALL BE CONDUCTED PER SFFD REQUIREMENTS, AND IF IT FAILS, AN ERRC SYSTEM SHALL BE INSTALLED
- 14 CABLING AND SHAFTS FOR FIRE ALARM SYSTEM SHALL BE PROVIDED WITH 2-HOUR
- 15 FIRE ALARM CONTRACTOR SHALL COMPLY WITH 2013 NFPA 72, INCLUDING LOW FREQUENCY REQUIREMENTS FOR SLEEPING AREAS. A LIVING ROOM SHALL BE CONSIDERED A POTENTIAL
- 16. PROVIDE TWO-WAY COMMUNICATION DEVICE AT ELEVATOR AT ALL LEVELS ABOVE MEZZANINE,

BUILDING CODE DATA

- 2022 CALIFORNIA BUILDING CODES / TITLE 24 INCLUDING VOLUMES 1 & 2;
- W/ 2022 SAN FRANCISCO BUILDING CODE AMENDMENTS
- 2022 CALIFORNIA RESIDENTIAL CODE 2022 CALIFORNIA PLUMBING CODE; W/ SAN FRANCISCO PLUMBING CODE AMENDMENTS 2022 CALIFORNIA MECHANICAL CODE
- 2022 CALIFORNIA ELECTRICAL CODE 2022 CALIFORNIA FIRE CODE
- 2022 CALIFORNIA ENERGY CODE 2022 CALIFORNIA CALGREEN
- 2022 CALIFORNIA HISTORICAL CODE
- 2022 CALIFORNIA EXISTING BUILDING CODE 2022 NFPA 13 2022 NFPA 72

SCOPE OF WORK

NOT IN CONTRACT

NUMBER

NOMINAL NOT TO SCALE

ON CENTER

OVERHANG

OPENING

OPPOSITE

PLYWOOD

RELOCATED

RETURN AIR

ROOF DRAIN

REGISTER

REQUIRED

REDWOOD

SOUTH

REINFORCED

REFRIGERATOR

ROUGH OPENING

SELF-ADHERED

SOLID CORE SMOKE DETECTOR

SHEATHING

SPECIFICATION

SEE STRUCTURAL

STANDARD

STRUCTURAL SUSPENDED

TOWEL BAR

TOP OF SLAB

TOP OF PLATE

TOP OF CURB

TOP OF WALL

TELEVISION

TYPICAL

VERTICAL VERIFY IN FIELD

VERTICAL GRAIN

WASHING MACHINE

WATER HEATER

WATER CLOSET (TOILET)

WATERPROOF, WORK

WATER RESISTANT

ELECTRICAL/MECHANICAL SYMBOLS

DUPLEX OUTLET

FOURPLEX OUTLET

HALF-SWITCHED

FULLY SWITCHED

⇒ GFI GROUND FAULT INTERRUPT

JUNCTION BOX

S/CD MULTI-FUNCTION SMOKE & CO DETECTOR

AUTOMATIC SPRINKLER

GARAGE DOOR OPENER

DOOR BELL BUTTON

INTERCOM STATION

MOTION DETECTOR

SPEAKER OUTLET

SCENE CONTROL

SCENE CONTROL REMOTE

STEAM UNIT CONTROL

(2) CAT-6 & (2) RG6 QUAD

COLD WATER CONNECTION

HOT WATER CONNECTION

SUPPLY AIR REGISTER AT

WALL OR TOE SPACE

SUPPLY AIR REGISTER

SUPPLY AIR REGISTER

RETURN AIR GRILL AT

RETURN AIR GRILL AT

CEILING

EXHAUST FAN

RETURN AIR GRILL AT WALL

EXHAUST FAN/ LIGHT UNIT

(1) 24/4 PAIR CAT-3

CENTRAL VACUUM

GAS OUTLET

FLOOR DRAIN

DOWNSPOUT

THERMOSTAT

HOSE BIB

MASTER UNIT

PLUG MOLD

- CAT-6 (1) 24/4 PAIR CAT-6

HDMI

(1) RG6 QUAD

- MM1 (1) CAT-6 & (1) RG6 QUAD

ALARM KEYPAD

DOOR CHIME

HEAD

-DB

-DC

-□GD

-__KP

- SP

-∏SC

-__W

-USU

-UTV

-___MM2

-∏HDMI

 \rightarrow H

-+G

-+HB

○FD

ODS

-<u></u>1

ELECTRICAL OUTLET

ELECTRICAL OUTLET,

ELECTRICAL OUTLET FOR

240V ELECTRICAL OUTLET

FLUSH FLOOR MOUNTED

OUTLET, DIRECT WIRE

TONGUE AND GROOVE

TOILET PAPER HOLDER

UNLESS OTHERWISE

SYMBOL

TOP OF

SECTION

SIMILAR

BITUMINOUS FLASHING

SEE MECHANICAL DRAWING

RISE, RISER

PROPERTY LINE

PLASTIC LAMINATE

PRESSURE TREATED

N.T.S

RDWD

S.A.B.F.

S.M.D.

S.S.D.

STD.

SYM.

T.O.C.

T.O.W.

U.O.N

V.I.F.

THE PROJECT PROPOSES A LOT MERGER OF THE FOUR SUBJECT LOTS AT THE SOUTHEAST CORNER OF MARKET STREET AND DUBOCE AVENUE. AND THE CONSTRUCTION OF 23-STORY MIXED-USE STATE DENSITY BONUS PROJECT WITH 200 DWELLING UNITS. ON THE MARKET STREET FRONTAGE, THE BUILDING WILL BE 12 STORIES AND SETBACK TO INCORPORATE THE EXISTING 2-STORY COMMERCIAL BUILDING, WHICH IS A HISTORIC RESOURCE. THE PROJECT WILL ALSO FEATURE 61 PARKING SPACES IN AN UNDERGROUND GARAGE.

THE RTO-ZONED LOTS ARE SUBJECT TO FORM-BASED DENSITY VIA PLANNING CODE SEC. 207(C)(9).

INDIVIDUALLY REQUESTED STATE DENSITY BONUS

WAIVERS RTO: WAIVERS NCT-3: - OPEN SPACE (SEC 135) - OPEN SPACE (SEC 135)

- HEIGHT (SEC 260) - HEIGHT (SEC 260) - GROUND FLOOR COMMERCIAL (SEC 145.4) - GROUND FLOOR COMMERCIAL (SEC 145.4)

INCENTIVE CONCESSIONS:

- "COLLAPSE THE TIERS" SEC 415

PLANNING CODE SUMMARY:

PROJECT SITE: 1965 MARKET STREET, SAN FRANCISCO, CA 94103

CROSS STREET: DUBOCE AVE

ASSESSOR'S PARCEL #: BLOCK: 3534 / LOT: 058, 059, 061, 062

ZONING: NCT-3 / RTO LOT AREA: 16,823 SQ. FT.

HEIGHT LIMIT: NCT 85-X; PROPOSED HEIGHT 135'-8" RTO 40-X; PROPOSED HEIGHT 239'-10"

REQUIRED - 25% OF LOT @ FIRST RESIDENTIAL LEVEL & ABOVE IN NCT-3 **REAR SETBACK:**

> / @ AT GRADE & ABOVE IN RTO PROPOSED - 25% OF LOT @ FIRST RESIDENTIAL LEVEL & ABOVE

DWELLING DENSITY: RTO = 1:600

NCT-3 = NONEAPPROXIMATE NUMBER OF UNITS LOCATED WITHIN RTO LOT: 143 APPROXIMATE NUMBER OF UNITS LOCATED WITHIN NCT-3 LOT: 57 PROPOSED: FORM BASED DENSITY PER STATE DENSITY BONUS

DWELLING UNIT MIX: REQUIRED: - PER 207.6(c):

MINIMUM REQUIRED IS 40% 2-BEDROOM UNITS OR 30% TO BE 3-BEDROOMS OR 35% TO BE AT

LEAST 2 OR 3 BEDROOMS WITH 10% OF THE TOTAL CONTAINING 3 BEDROOMS.

PROVIDED:

108 UNITS WITH 2 BEDROOMS OR GREATER PROVIDED (54%),

PARKING: PERMITTED - 0.75 PER RESIDENTIAL UNIT IN RTO / 0.5 PER RESIDENTIAL UNIT IN NCT-3

- MAX.: 135.75 PARKING STALLS = [(143x0.75)+(57x0.5)] PROPOSED - 0.3 PER RESIDENTIAL UNIT: 61 RESIDENTIAL PARKING STALLS (INCLUDES 2 ADA)

(INCLUDES 2 ADA COMPLIANT PARKING)

NOTE: ALL OFF-STREET PARKING IS UNBUNDLED AND WILL BE SOLD SEPARATELY FROM THE DWELLING UNITS IN COMPLIANCE WITH SFPC SECTION 167

CAR SHARE: REQUIRED - 1 PER 50-200 DWELLING UNITS

> PROPOSED - 1 CAR SHARE PROVIDED NOTE: ACCESS TO CAR SHARE BY PUBLIC WILL BE FACILITATED BY TEMPORARY SECURITY CODES

> > 10 CLASS 2 BICYCLE PARKING FOR RESIDENTIAL UNITS

THAT ENABLE USERS ACCESS TO BUILDING GARAGE VIA BUILDING SECURITY SYSTEM

BIKE PARKING: REQUIRED: 125 CLASS 1 BICYCLE PARKING FOR RESIDENTIAL UNITS 10 CLASS 2 BICYCLE PARKING FOR RESIDENTIAL UNITS PROPOSED: 125 CLASS 1 BICYCLE PARKING FOR RESIDENTIAL UNITS

REQUIRED (PER RTO/NCT-3)- 133/100 SF PER RESIDENTIAL UNIT = 17,689 RTO+5,300 NCT-3 = 22,989 sq ft **COMMON OPEN SPACE:** PROVIDED - 4.953 SF COMMON ROOF DECKS & PATIOS

PRIVATE OPEN SPACE: REQUIRED (PER RTO/NCT-3)- 100/80 SF PER RESIDENTIAL UNIT

PROVIDED - 9 UNITS PROVIDED WITH REQ'D MIN. PRIVATE OPEN SPACE

INCLUSIONARY HOUSING: 28 ONSITE INCLUSIONARY UNITS AN 88.75% DENSITY BONUS IS REQUESTED PROVIDING 25% OF UNITS AT 50% AMI

TYPE I-A CONSTRUCTION.

SF BETTER ROOFS: NON APPLICABLE AS BUILDING CONTAINS MORE THAN 10 OCCUPIED FLOORS

BUILDING CODE SUMMARY:

CONSTRUCTION TYPE: OCCUPANT GROUP:

R-2: RESIDENTIAL - GROUND FLOOR TO STORY 23 S-2: STORAGE/PARKING GARAGE - BASEMENT **B: BUSINESS**

UNITS COUNT: PROPOSED - 200 RESIDENTIAL UNITS

BLDG. HT. & PROPOSED: NUMBER OF STORY: BLDG. HT. 239'-10"

LOT AREA:

STORIES: 23 STORY BLDG OVER BASEMENT TYPE 1A (S-2 & R-2) BUILDING IS A HIGH RISE.

HIGHEST OCCUPIED FLOOR IS 120'-0" ABOVE THE LOWEST LEVEL OF FIRE DEPARTMENT ACCESS

PROPOSED:

ACCESSIBILITY:

BLDG. AREA:

220,889 SQ. FT. (INCLUDING BASEMENT) GROSS FLOOR AREA:

SPRINKLERS: BUILDING IS REQUIRED TO BE SPRINKLER PROTECTED PER NFPA 13 AND STANDPIPE OUTLETS REQUIRED IN EACH STAIRWELL FLOOR LANDING AND ROOF PER SFBC SEC. 905 AND NFPA 14.

FIRE ALARM SYSTEM: AUTOMATIC FIRE ALARM SYSTEM TO BE INSTALLED IN ACCORDANCE WITH NFPA 72 AND

SFBC SEC. 907

EMERGENCY RESPONDER: ALL NEW BUILDINGS SHALL HAVE APPROVED RADIO COVERAGE FOR EMERGENCY RADIO: RESPONDERS WITHIN THE BUILDING. UPON COMPLETION OF THE BUILDING

CONSTRUCTION, A RADIO COVERAGE TEST SHALL BE CONDUCTED PER THE SPECIFIC REQUIREMENTS OF SFFC AND NFPA 72 AND IF THE TEST FAILS, AN EMERGENCY RADIO COVERAGE SYSTEM (ERRCS) SHALL BE INSTALLED.

SMOKE AND CO ALARMS: PROVIDE SMOKE ALARMS PER 2022 SFFC SEC. 907.2.11 AND CARBON MONOXIDE ALARMS PER CFC 908.7 THROUGHOUT BUILDING.

ACCESSIBLE ELEVATOR: BLDG. IS A COVERED MULTIFAMILY DWELLING WITH AN ELEVATOR THAT MEETS THE CBC CHAPTER 11A REQUIREMENTS; FOR ENTIRE BLDG.

CBC SEC. 1134A, BATHING AND TOILET FACILITIES; PROJECT CONFORMS WITH OPTION 2

16,823 SQ. FT. LOT AREA

COMPLIANCE.

DEFERRED SUBMITTALS:

ADDENDA SCHEDULE:

SPRINKLER SYSTEM IS UNDER SEPARATE PERMIT

FIRE ALARM UNDER SEPARATE PERMIT EMERGENCY EVACUATION SIGNS UNDER SEPARATE PERMIT

9,878

9,878

6,541

6,749

6,749

6,749

6,749

6,749

6,749

6,749

6,749

5,857

STAIRWELL IDENTIFICATION SIGNS & EVACUATION SIGNS UNDER SEPARATE PERMIT

ASSEMBLY PERMIT FOR ROOF UNDER SEPARATE PERMIT

ADDENDUM #1: FOUNDATION & PT PODIUM (INCLUDES CONC. COLUMNS & WALLS) ADDENDUM #2: SUPERSTRUCTURE (WOOD FRAMING ABOVE BASEMENT TYPE I-A) ADDENDUM #3: BLDG PLANS, ARCHITECTURAL, MEP, TITLE 24 ADDENDUM #4: FIRE SPRINKLERS SYSTEM

ADDENDUM #5: ERRC ADDENDUM #6: FIRE ALARM / TWO-WAY COMMUNICATION FOR ELEVATOR

BUILDING GROSS AREA

GROSS FLOOR AREA, PER SF PLANNING CODE BEFORE LEVEL TYPE GROSS AREA (SQ FT) **BASEMENT** 16,145 **GROUND FLOOR** 2ND STORY 3RD STORY 4TH STORY 5TH STORY 6TH STORY 7TH STORY 8TH STORY 9TH STORY 10TH STORY

BUILDING GROSS AREA DEDUCTIONS:

-16.145 SF UNDERGROUND PARKING & BIKE STORAGE ELEVATOR SHAFT ON GROUND FLOOR 204,546 SF GROSS FLOOR AREA PER PLANNING

UNIT MIX %

40.0%

46.5%

2.5%

5.0%

6.0%

100%

1,295	<u>UNIT MI</u>	X - RESIDENT	
0,665	UNIT TYF	PE QUANTITY	
0,811	1 BD	80	
0,574	2 BD	93	_
0,741	2 BD + DE	N 5	
0,752	3 BD	10	_
0,752	STUDIO	12	_
0,752	TOTAL	200	
0,752			_
0,752			
0,752			

GROSS FLOOR AREA MEASURED PER SF PLANNING CODE SEC 102

FIRE RESISTANCE SUMMARY **TABLE 601 COMPLIANCE**

11TH STORY

12TH STORY

13TH STORY

14TH STORY

15TH STORY

16TH STORY

17TH STORY

18TH STORY

19TH STORY

20TH STORY

21ST STORY

22ND STORY

23RD STORY

FIRE-RESISTANCE RATING REQUIREMENTS FOR BUILDING ELEMENTS (HOURS)

BUILDING ELEMENT		PEI	TYF	PE II	TYP	EIII	TYPE IV	TYP	ΕV
		В	Α	В	Α	В	HT	A⁴	В
Primary structural frame ^f (see Section 202)	3ª	2ª	1	0	1	0	HT	1	0
Bearing walls Exterior ^{e, f} Interior	3 3ª	2 2ª	1 1	0	2 1	2 0	2 1/HT	1	0
Nonbearing walls and partitions Exterior				Se	e Table	602			
Nonbearing walls and partitions Interior ^d	0	0	0	0	0	0	See Section 602.4.6	0	0
Floor construction and associated secondary members (see Section 202)	2	2	1	0	1	0	НТ	1	0
Roof construction and associated secondary members (see Section 202)	1 ¹ / ₂ ^b	1 ^{b,c}	1 ^{b,c}	O _c	1 ^{b,c}	0	НТ	1 ^{b,c}	0

- For SI: 1 foot = 304.8 mm
- a. Roof supports: Fire-resistance ratings of primary structural frame and bearing walls are permitted to be reduced by 1 hour where supporting a roof only. b. 1. Except in Group A, E, F-1, H, I, L, M, R-1, R-2, R-2.1 and S-1 occupancies, high-rise buildings, and other applications listed in Section 1.11 regulated by the Office of the State Fire Marshal, fire protection of structural members shall not be required, including protection of roof framing and decking where every part of the roof construction is 20 feet or more above any floor immediately below. Fire-retardant-treated wood members shall be allowed to be used for such
- b. 2 For Group A, E, I, L, R-1, R-2, and R-2.1 occupancies, high-rise buildings, and other applications listed in Section 1.11 regulated by the Office of the State Fire Marshal, fire protection of members other than the structural frame shall not be required, including protection of roof framing and decking where every part of the roof construction is 20 feet or more above any floor immediately below. Fire-retardant-treated wood members shall be allowed to be used for such
- b. 3. One-story portions of Group A and E assembly occupancies the roof-framing system of Type II A or Type III A construction may be of unprotected construction when such roof-framing system is open to the assembly area and does not contain concealed spaces.
- c. In all occupancies, heavy timber shall be allowed where a 1-hour or less fire-resistance rating is required.
- d. Not less than the fire-resistance rating required by other sections of this code. e. Not less than the fire-resistance rating based on fire separation distance (see Table 602).
- f. Not less than the fire-resistance rating as referenced in Section 704.10.

TABLE 602 COMPLIANCE


FIRE-RESISTANCE RATING REQUIREMENTS FOR BUILDING ELEMENTS (HOURS)

		,		
FIRE SEPARATION DISTANCE	TYPE OF CONSTRUCTION	OCCUPANCY	OCCUPANCY	OCCUPANCY
		GROUP Hf, L	GROUP F-1, M, S-1g	GROUP A, B, E, F-2, I, Rh,i, S-29,
(feet)				Ub,h,i
< 5 ^c	All	3	2	1
	IA	3	2	1
≥ 5 to < 10	Others	2	1	1
	IA, IB	2	1	1 d
	IIB, VB	1	0	0
> 10 to < 30	Others	1	1	1 d
>30	All	0	0	0

- a. Load-bearing exterior walls shall also comply with the fire-resistance rating requirements of Table 601. b. For special requirements for Group U occupancies, see Section 406.3.
- c. See Section 706.1.1 for party walls.
- d. Open parking garages complying with Section 406 shall not be required to have a fire-resistance rating. e. The fire-resistance rating of an exterior wall is determined based upon the fire separation distance of the exterior wall and the story in
- which the wall is located. f. For special requirements for Group H occupancies, see Section 415.5.
- g. For special requirements for Group S aircraft hangars, see Section 412.4.1.
- h. Where Table 705.8 permits nonbearing exterior walls with unlimited area of unprotected openings, the required fire-resistance rating for
- i. Group R-3 and Group U occupancies when used as accessory to Group R-3 occupancies, shall not be required to have a fire-resistance rating where the fire separation distance is 5 feet or more; or when equipped throughout with an automatic residential fire sprinkler system installed in accordance with Section 903.3 the fire-resistance rating shall not be required where the fire separation distance is 3 feet or

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REVISION CHANGE

04/17/24 SB 330 APPLICATION

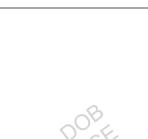APPLICANT

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PROJECT NAME

Ruben, Junius & Rose, LLP

1965 Market St

San Francisco, CA 94103

BLOCK/LOT 3534 / 058, 059, 061 & 062

DRAWN BY TG / MP / SP **CHECKED BY** PROJECT NO. 202314

4/18/24

SCALE

AS NOTED

PROJECT DATA


DATE OF PUBLICATION

DRAWING NO. 2 OF 24

1965 MARKET STREET, SAN FRANCISCO 23 STORIES TYPE 1A + UNDERGROUND PARKING - 200 RESIDENTIAL UNITS





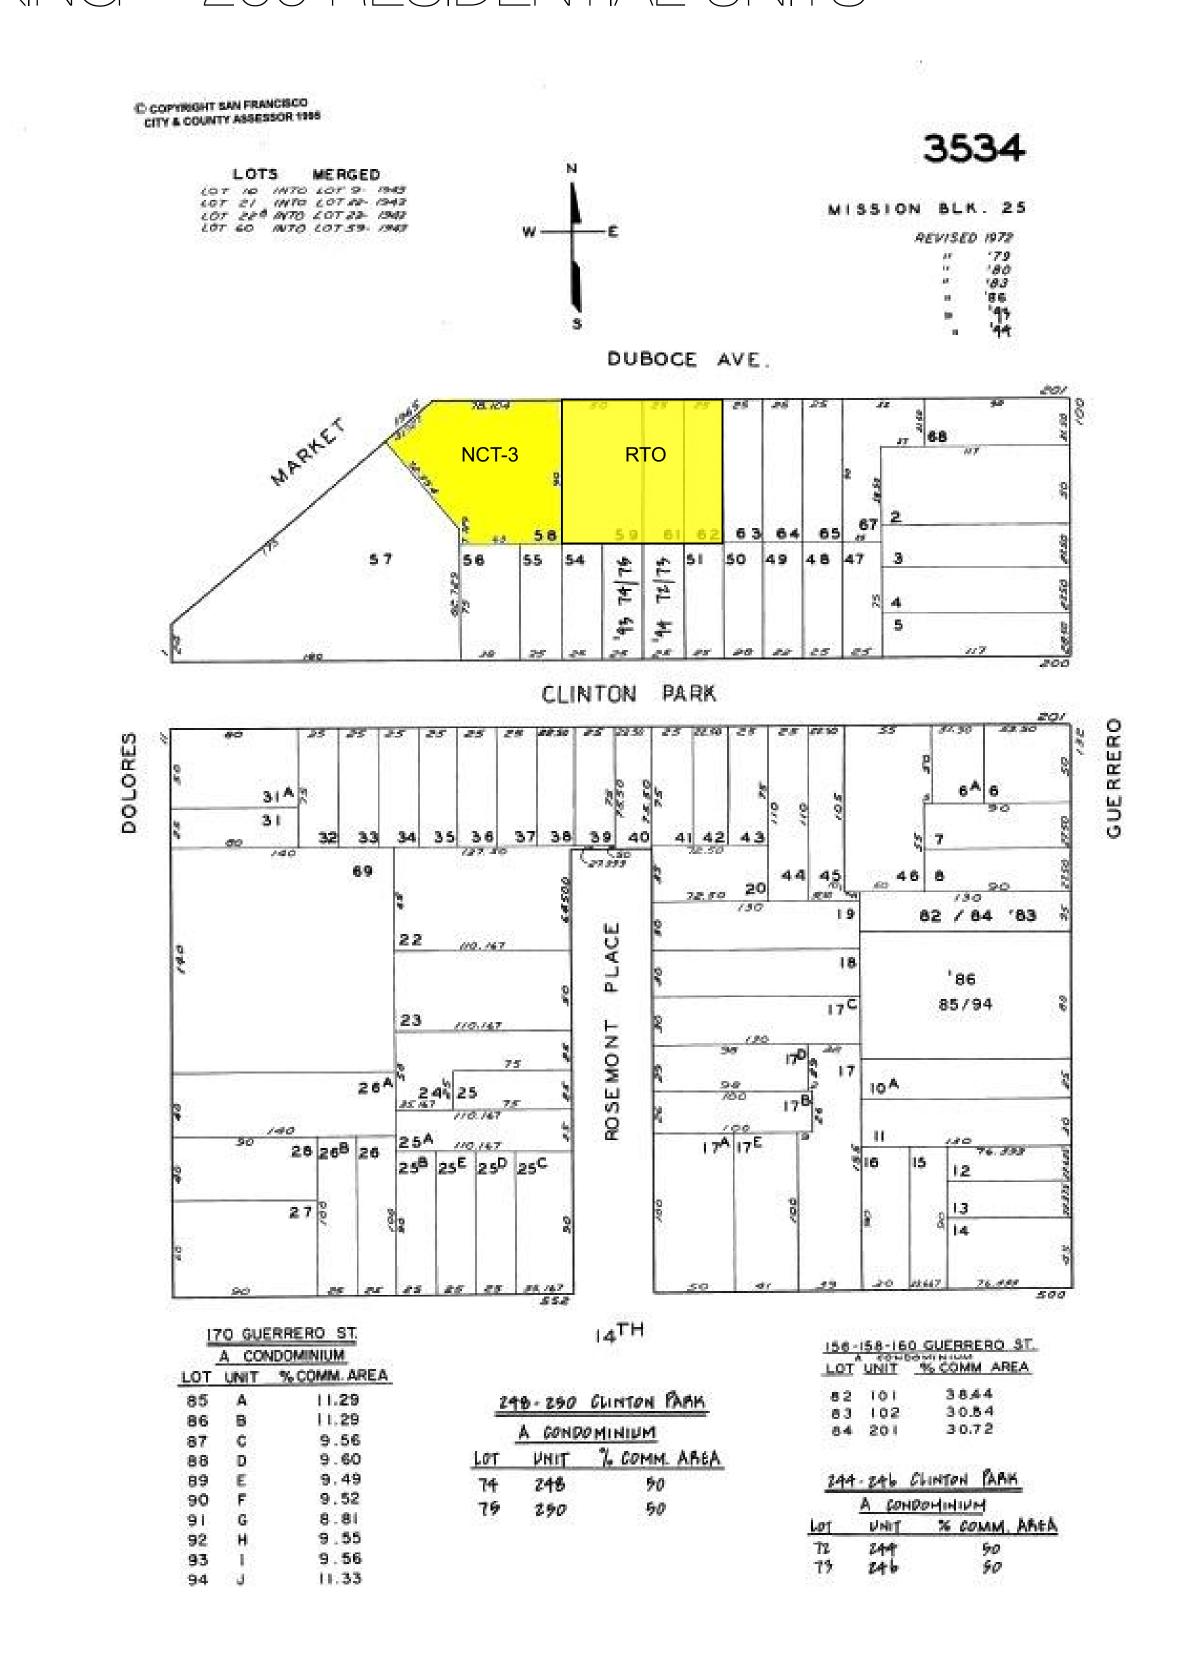

SITE INFORMATION:

Project Address: 1965 Market Street and Duboce. San Francisco CA, 94103, USA

Assessors Parcel 3534/058, 3534/059, 3534/061 & 3534/062

Zoning District: NCT-3 & RTO
Height & Bulk: 85-X, 40-X & 50-X
Lot Area: 16,823 SF

DENSITY BONUS STUDY

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428 SOUTH VAN NESS AVENUE

428 SOUTH VAN NESS AVENU SAN FRANCISCO, CA 94103 415.649.6202 mail@rg-architecture.com





NO. DATE ISSUE

REVISIONS

04/17/24 SB 330 APPLICATION

REVISION CHANGE

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04/17/24 SB 330 APPLICATION

APPLICANT
Ruben, Junius & Rose, LLP
1 Bush St. Ste. 600

PROJECT NAME

1965 Market St

San Francisco, CA 94104

San Francisco, CA 94103

BLOCK/LOT 3534 / 058, 059, 061 & 062

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SCALE


RG **PROJECT NO.** 202314

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DENSITY BONUS
STUDY

DRAWING NO. 3 OF 24


BASE PROJECT STUDY

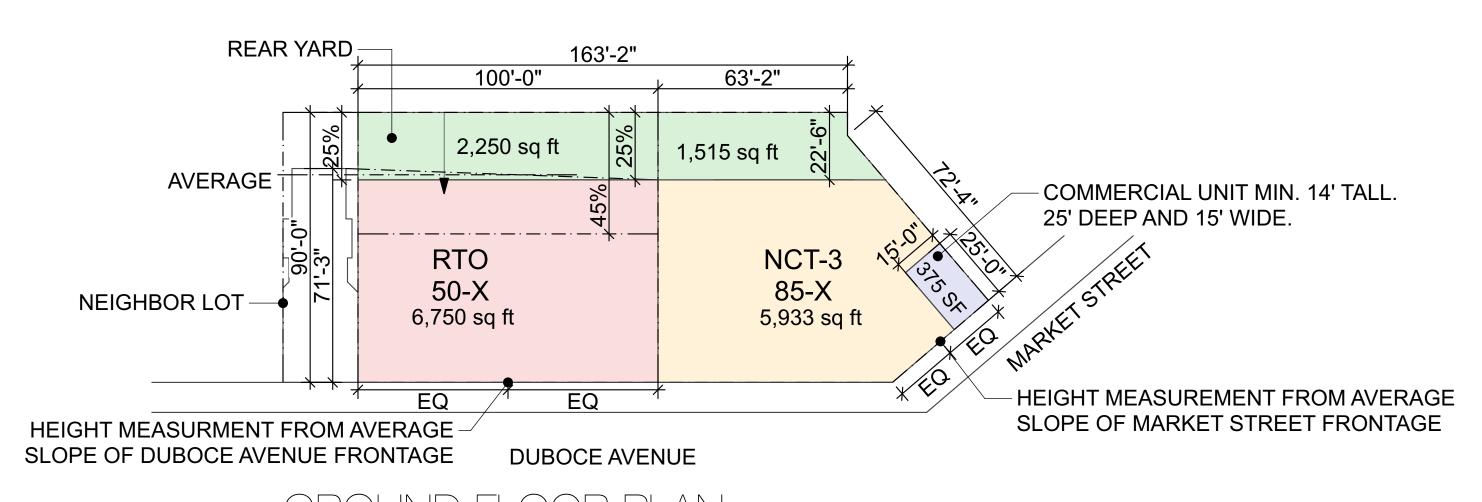


DUBOCE AVENUE

100'-0"

2ND FLOOR

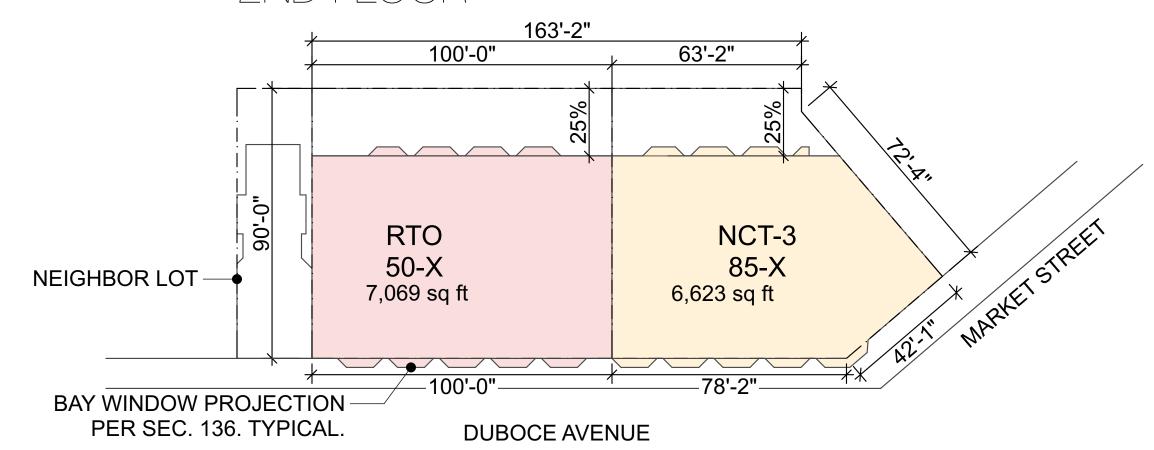



3RD FLOOR to 4TH FLOOR

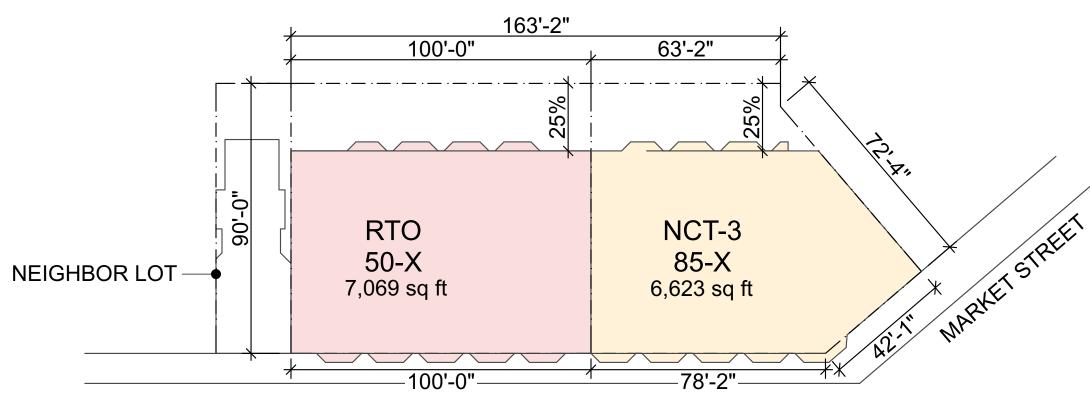


DUBOCE AVENUE

5TH FLOOR TO 6TH FLOOR

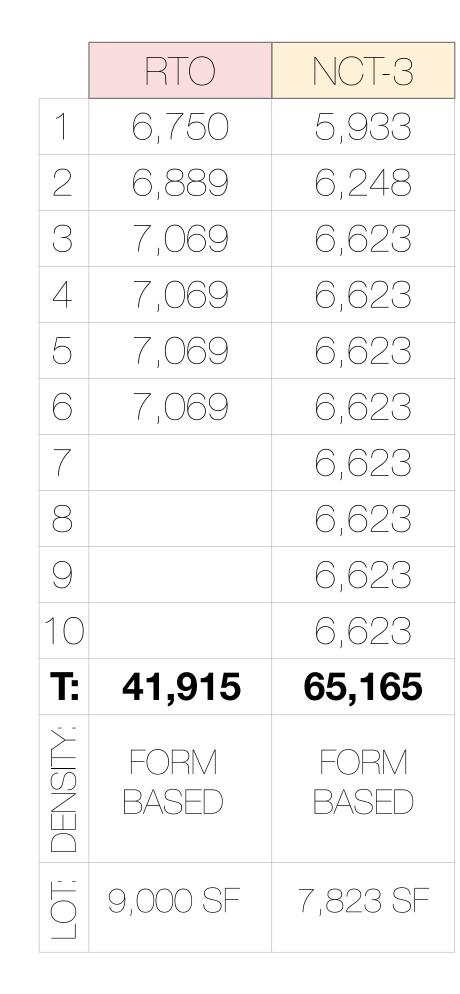

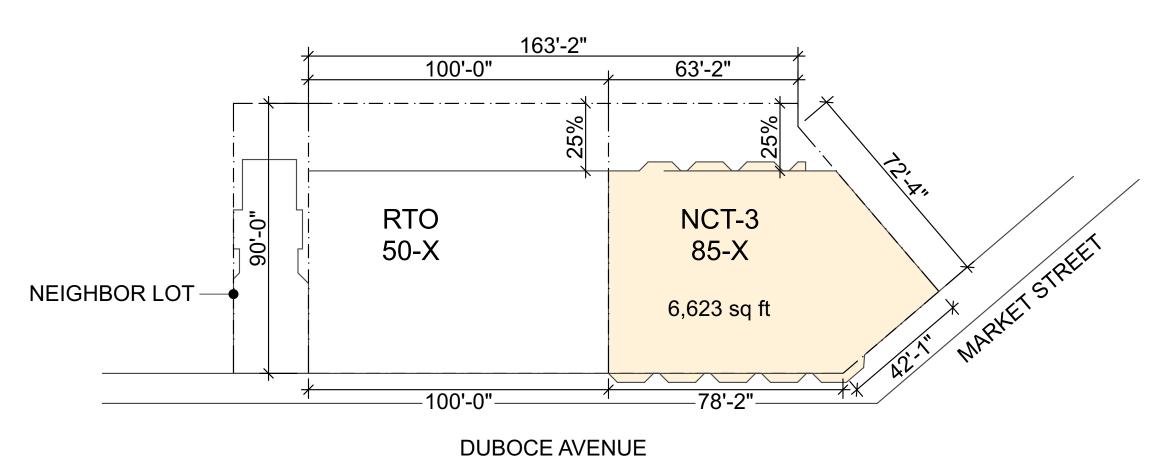

7TH FLOOR TO 10TH FLOOR

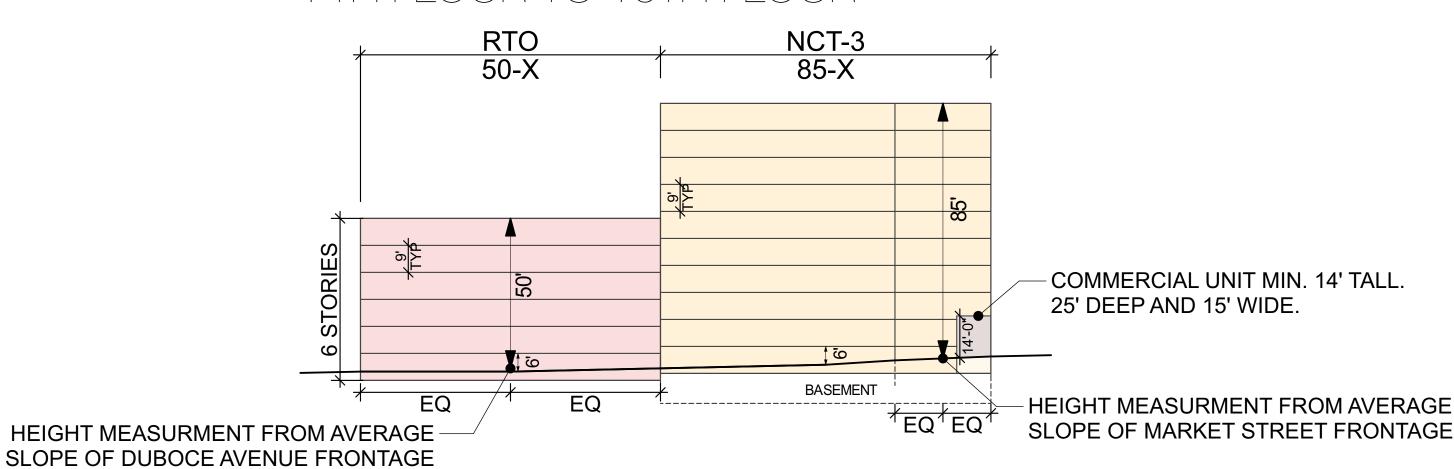

TYPICAL SECTION

SUMMARY:

BASE PROJECT RESIDENTIAL FLOOR AREA:
CALCULATE THE BASE PROJECT'S RESIDENTIAL FLOOR AREA,
INCLUDING EACH STORY OF A HYPOTHETICAL BUILDING, ON THE
PROPOSED SITE.

NTC-3 - TOTAL RESIDENTIAL FLOOR AREA (RFA) 65,165 SF RTO - TOTAL RESIDENTIAL FLOOR AREA (RFA) 41,915 SF

RFA = 65,165 SF + 41,915 SF = 107,080 SF : 107,080 SF + 88.75 % = 202,113 SF

THE MAXIMUM ALLOWABLE DENSITY BONUS PROJECT SHALL NOT EXCEED 202,113 SF OF RESIDENTIAL FLOOR AREA.

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APPLICANT

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BASE PROJECT

DRAWING NO. 4 OF 24

BUILDING DATA:

Total Gross Area: 220,889 SF including underground garage.

Stories: 23 over basement

Height: 239'-10" Per Sec. 260

High Rise: Yes

Rear Yard: 25% of Lot Depth. 21.4% of Lot Size.

Open Space: 3570 SF Rear Yard & 4,953 SF Roof Deck.

Construction: IA
Units: 200
Parking: 61

Occupancy Type: R-2 Residential Units

S-2 Parking

B Business

Fire Service Elevator: Yes. Two Fire Service Elevators are required.

Tall Building Per DBI: Less than 240' tall, therefore it is not a "Tall Building".


Individually Requested State Density Bonus

TOTAL RESIDENTIAL AREA (RFA):

2ND STORY 10,665 3RD STORY 10,811 4TH STORY 10,574 5TH STORY 10,752 6TH STORY 10,752 7TH STORY 10,752 8TH STORY 10,752 9TH STORY 10,752 10TH STORY 10,752 10TH STORY 10,752 11TH STORY 10,752 11TH STORY 10,752 11TH STORY 10,752 12TH STORY 10,752 12TH STORY 10,752 12TH STORY 10,752 12TH STORY 10,752 13TH STORY 10,752 13TH STORY 10,752 14TH STORY 10,752 15TH STORY 10,752 15TH STORY 10,749 16TH STORY 10,749 16	BASEMENT	0
3RD STORY 10,811 4TH STORY 10,574 5TH STORY 10,741 6TH STORY 10,752 7TH STORY 10,752 8TH STORY 10,752 9TH STORY 10,752 10TH STORY 10,752 11TH STORY 10,752 12TH STORY 9,878 13TH STORY 9,878 13TH STORY 6,541 15TH STORY 6,749 16TH STORY 6,749 18TH STORY 6,749 19TH STORY 6,749 20TH STORY 6,749 21ST STORY 6,749 23RD STORY 6,749 23RD STORY 5,857	GROUND FLOOR	8,058
4TH STORY 10,574 5TH STORY 10,741 6TH STORY 10,752 7TH STORY 10,752 8TH STORY 10,752 8TH STORY 10,752 9TH STORY 10,752 10TH STORY 10,752 11TH STORY 10,752 12TH STORY 10,752 12TH STORY 10,752 12TH STORY 9,878 13TH STORY 9,878 14TH STORY 6,541 15TH STORY 6,749 16TH STORY 6,749 19TH STORY 6,749 20TH STORY 6,749 21ST STORY 6,749 22ND STORY 6,749 23RD STORY 5,857	2ND STORY	10,665
5TH STORY 10,741 6TH STORY 10,752 7TH STORY 10,752 8TH STORY 10,752 9TH STORY 10,752 10TH STORY 10,752 11TH STORY 10,752 12TH STORY 9,878 13TH STORY 9,878 14TH STORY 6,541 15TH STORY 6,749 16TH STORY 6,749 18TH STORY 6,749 19TH STORY 6,749 20TH STORY 6,749 21ST STORY 6,749 22ND STORY 6,749 23RD STORY 5,857	3RD STORY	10,811
6TH STORY 10,752 7TH STORY 10,752 8TH STORY 10,752 9TH STORY 10,752 10TH STORY 10,752 11TH STORY 10,752 11TH STORY 10,752 12TH STORY 9,878 13TH STORY 9,878 14TH STORY 6,541 15TH STORY 6,749 16TH STORY 6,749 18TH STORY 6,749 20TH STORY 6,749 21ST STORY 6,749 23RD STORY 5,857	4TH STORY	10,574
7TH STORY 10,752 8TH STORY 10,752 9TH STORY 10,752 10TH STORY 10,752 11TH STORY 10,752 12TH STORY 9,878 13TH STORY 9,878 14TH STORY 6,541 15TH STORY 6,749 16TH STORY 6,749 17TH STORY 6,749 19TH STORY 6,749 20TH STORY 6,749 21ST STORY 6,749 23RD STORY 5,857	5TH STORY	10,741
8TH STORY 10,752 9TH STORY 10,752 10TH STORY 10,752 11TH STORY 10,752 12TH STORY 9,878 13TH STORY 9,878 14TH STORY 6,541 15TH STORY 6,749 16TH STORY 6,749 17TH STORY 6,749 18TH STORY 6,749 20TH STORY 6,749 21ST STORY 6,749 23RD STORY 5,857	6TH STORY	10,752
9TH STORY 10,752 10TH STORY 10,752 11TH STORY 10,752 12TH STORY 9,878 13TH STORY 9,878 14TH STORY 6,541 15TH STORY 6,749 16TH STORY 6,749 17TH STORY 6,749 18TH STORY 6,749 20TH STORY 6,749 22ND STORY 6,749 23RD STORY 5,857	7TH STORY	10,752
10TH STORY 10,752 11TH STORY 10,752 12TH STORY 9,878 13TH STORY 9,878 14TH STORY 6,541 15TH STORY 6,749 16TH STORY 6,749 17TH STORY 6,749 18TH STORY 6,749 20TH STORY 6,749 21ST STORY 6,749 23RD STORY 5,857	8TH STORY	10,752
11TH STORY 10,752 12TH STORY 9,878 13TH STORY 9,878 14TH STORY 6,541 15TH STORY 6,749 16TH STORY 6,749 17TH STORY 6,749 18TH STORY 6,749 19TH STORY 6,749 20TH STORY 6,749 21ST STORY 6,749 22ND STORY 6,749 23RD STORY 5,857	9TH STORY	10,752
12TH STORY 9,878 13TH STORY 9,878 14TH STORY 6,541 15TH STORY 6,749 16TH STORY 6,749 17TH STORY 6,749 18TH STORY 6,749 20TH STORY 6,749 21ST STORY 6,749 23RD STORY 5,857	10TH STORY	10,752
13TH STORY 9,878 14TH STORY 6,541 15TH STORY 6,749 16TH STORY 6,749 17TH STORY 6,749 18TH STORY 6,749 19TH STORY 6,749 20TH STORY 6,749 21ST STORY 6,749 22ND STORY 6,749 23RD STORY 5,857	11TH STORY	10,752
14TH STORY 6,541 15TH STORY 6,749 16TH STORY 6,749 17TH STORY 6,749 18TH STORY 6,749 19TH STORY 6,749 20TH STORY 6,749 21ST STORY 6,749 22ND STORY 6,749 23RD STORY 5,857	12TH STORY	9,878
15TH STORY 6,749 16TH STORY 6,749 17TH STORY 6,749 18TH STORY 6,749 19TH STORY 6,749 20TH STORY 6,749 21ST STORY 6,749 22ND STORY 6,749 23RD STORY 5,857	13TH STORY	9,878
16TH STORY 6,749 17TH STORY 6,749 18TH STORY 6,749 19TH STORY 6,749 20TH STORY 6,749 21ST STORY 6,749 22ND STORY 6,749 23RD STORY 5,857	14TH STORY	6,541
17TH STORY 6,749 18TH STORY 6,749 19TH STORY 6,749 20TH STORY 6,749 21ST STORY 6,749 22ND STORY 6,749 23RD STORY 5,857	15TH STORY	6,749
18TH STORY 6,749 19TH STORY 6,749 20TH STORY 6,749 21ST STORY 6,749 22ND STORY 6,749 23RD STORY 5,857	16TH STORY	6,749
19TH STORY 6,749 20TH STORY 6,749 21ST STORY 6,749 22ND STORY 6,749 23RD STORY 5,857	17TH STORY	6,749
20TH STORY 6,749 21ST STORY 6,749 22ND STORY 6,749 23RD STORY 5,857	18TH STORY	6,749
21ST STORY 6,749 22ND STORY 6,749 23RD STORY 5,857	19TH STORY	6,749
22ND STORY 6,749 23RD STORY 5,857	20TH STORY	6,749
23RD STORY 5,857	21ST STORY	6,749
· · · · · · · · · · · · · · · · · · ·	22ND STORY	6,749
TOTAL 201,507 ft ²	23RD STORY	5,857
	TOTAL	201,507 ft ²

DWELLING UNIT INVENTORY:

UNIT TYPE	QUANTITY	UNIT MIX %	
1 BD	80	40.0%	
2 BD	93	46.5%	
2 BD + DEN	5	2.5%	54.0%
3 BD	10	5.0%	
STUDIO	12	6.0%	
TOTAL	200	100%	

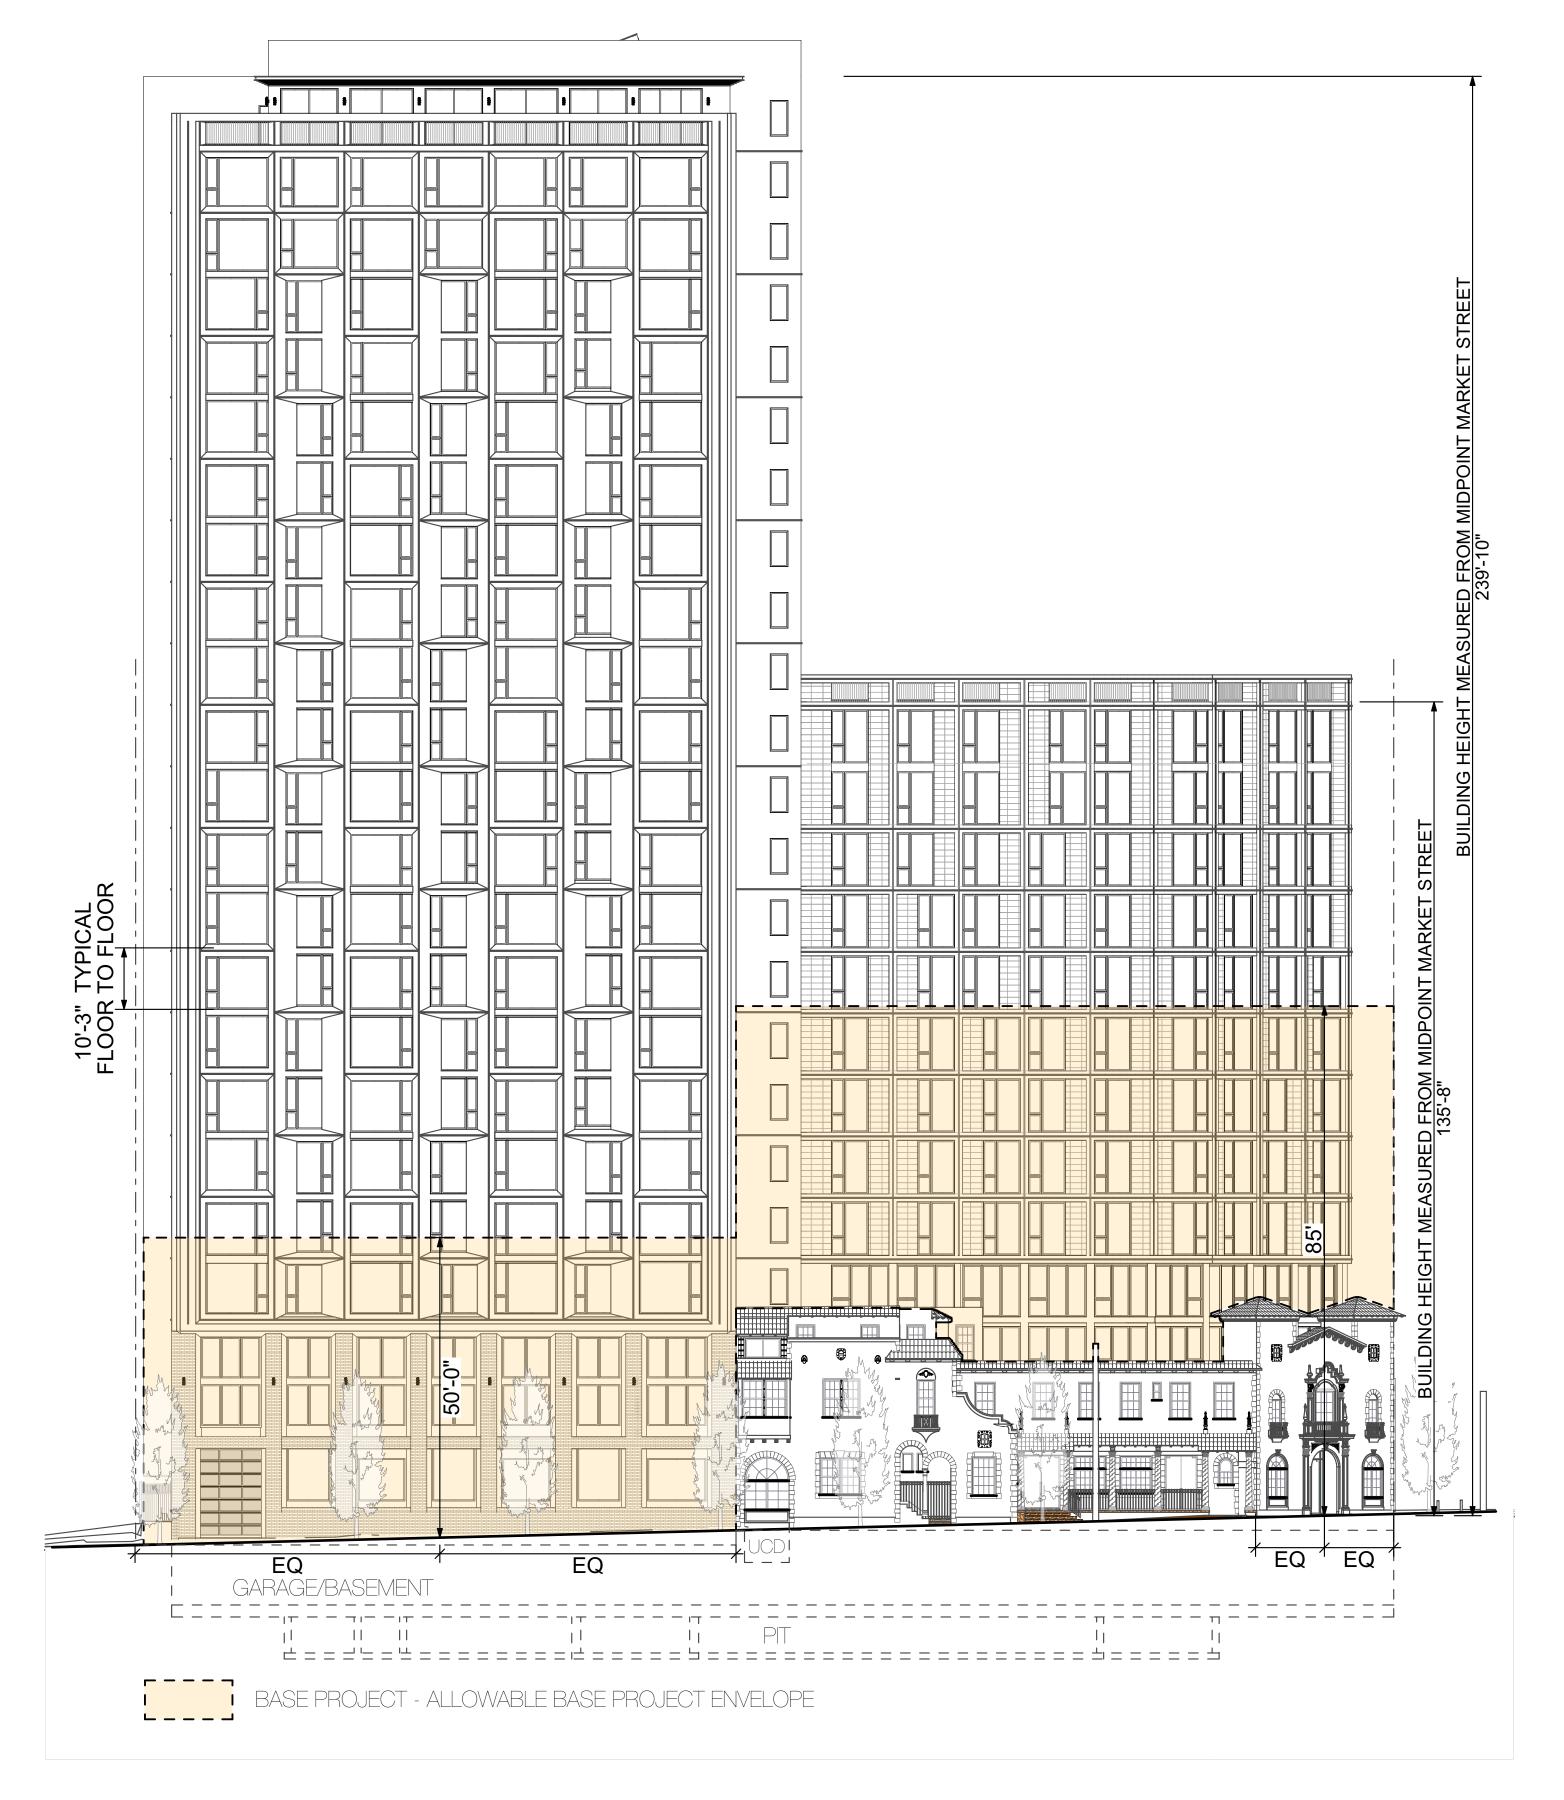

ELEVATION FROM DUBOCE AVENUE AND MARKET STREET INTERSECTION

THE MAXIMUM ALLOWABLE DENSITY BONUS PROJECT SHALL NOT EXCEED 202,113 SF OF RESIDENTIAL FLOOR AREA.

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Ruben, Junius & Rose, LLP
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BUILDING DATA & DENSITY BONUS

DRAWING NO. 5 OF 24



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RENDERINGS

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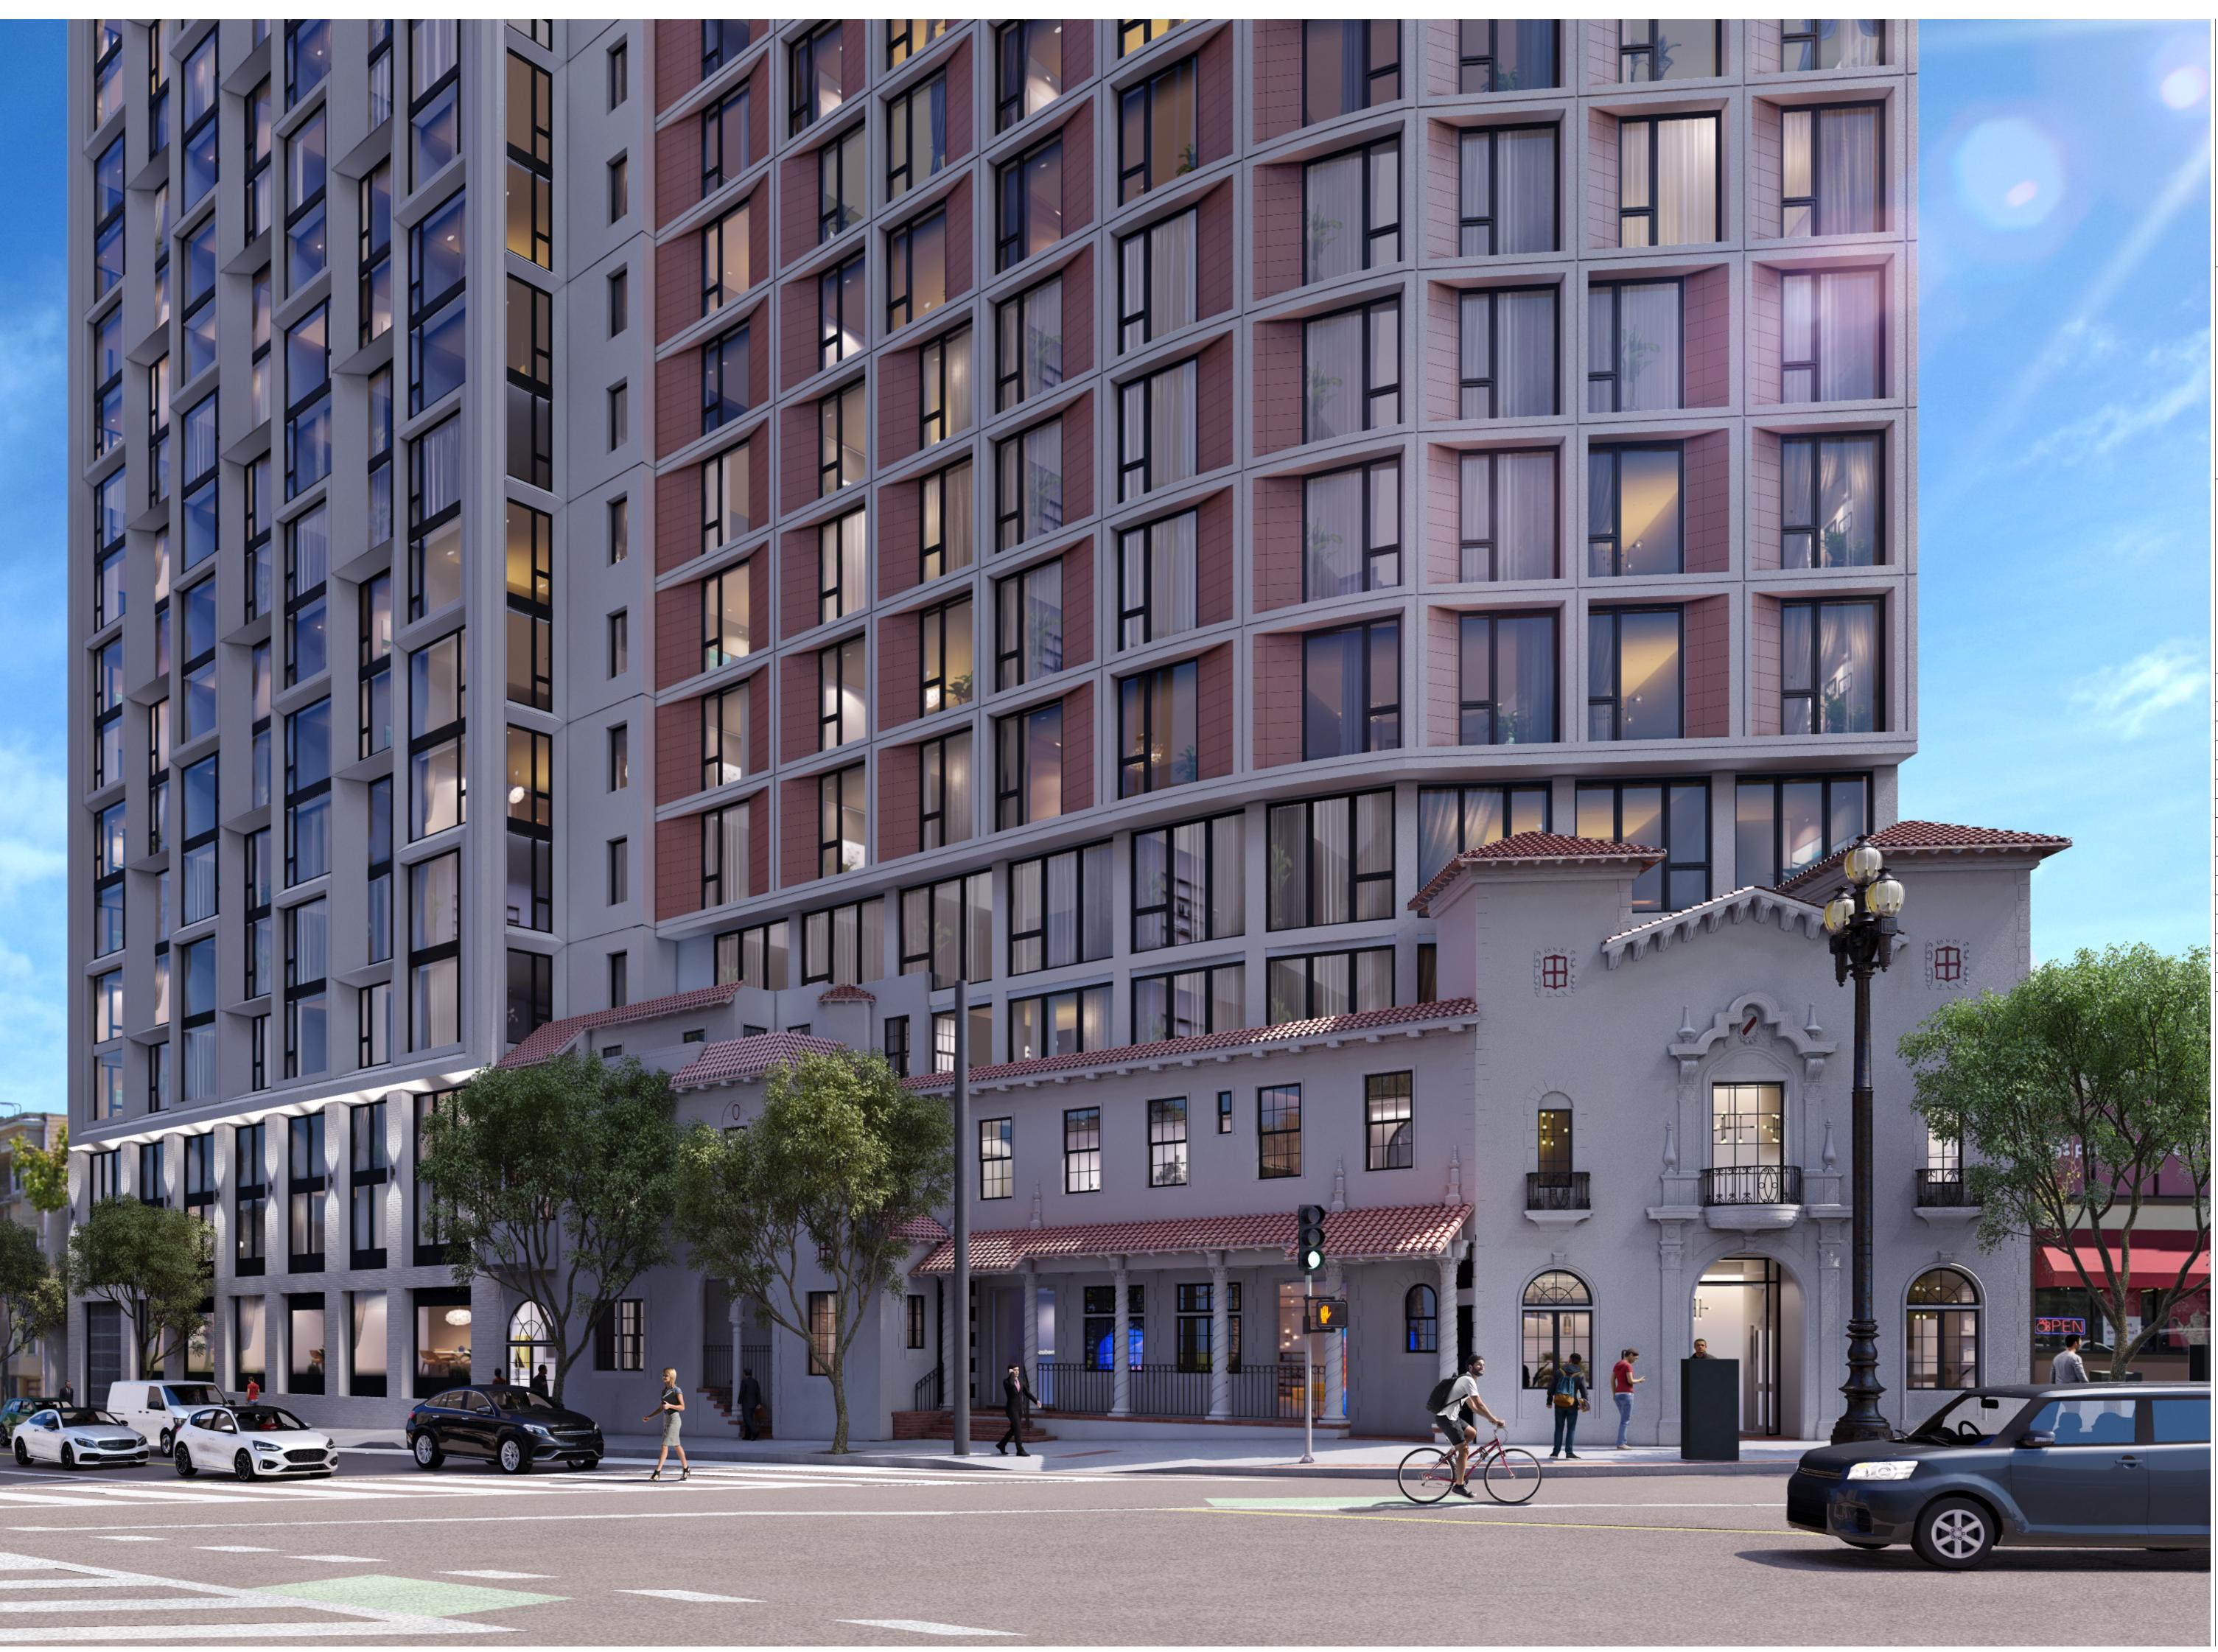
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RENDERINGS

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San Francisco, CA 94104

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1965 Market St

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BLOCK/LOT 3534 / 058, 059, 061 & 062

3534 / 058, 059, 061 & 0


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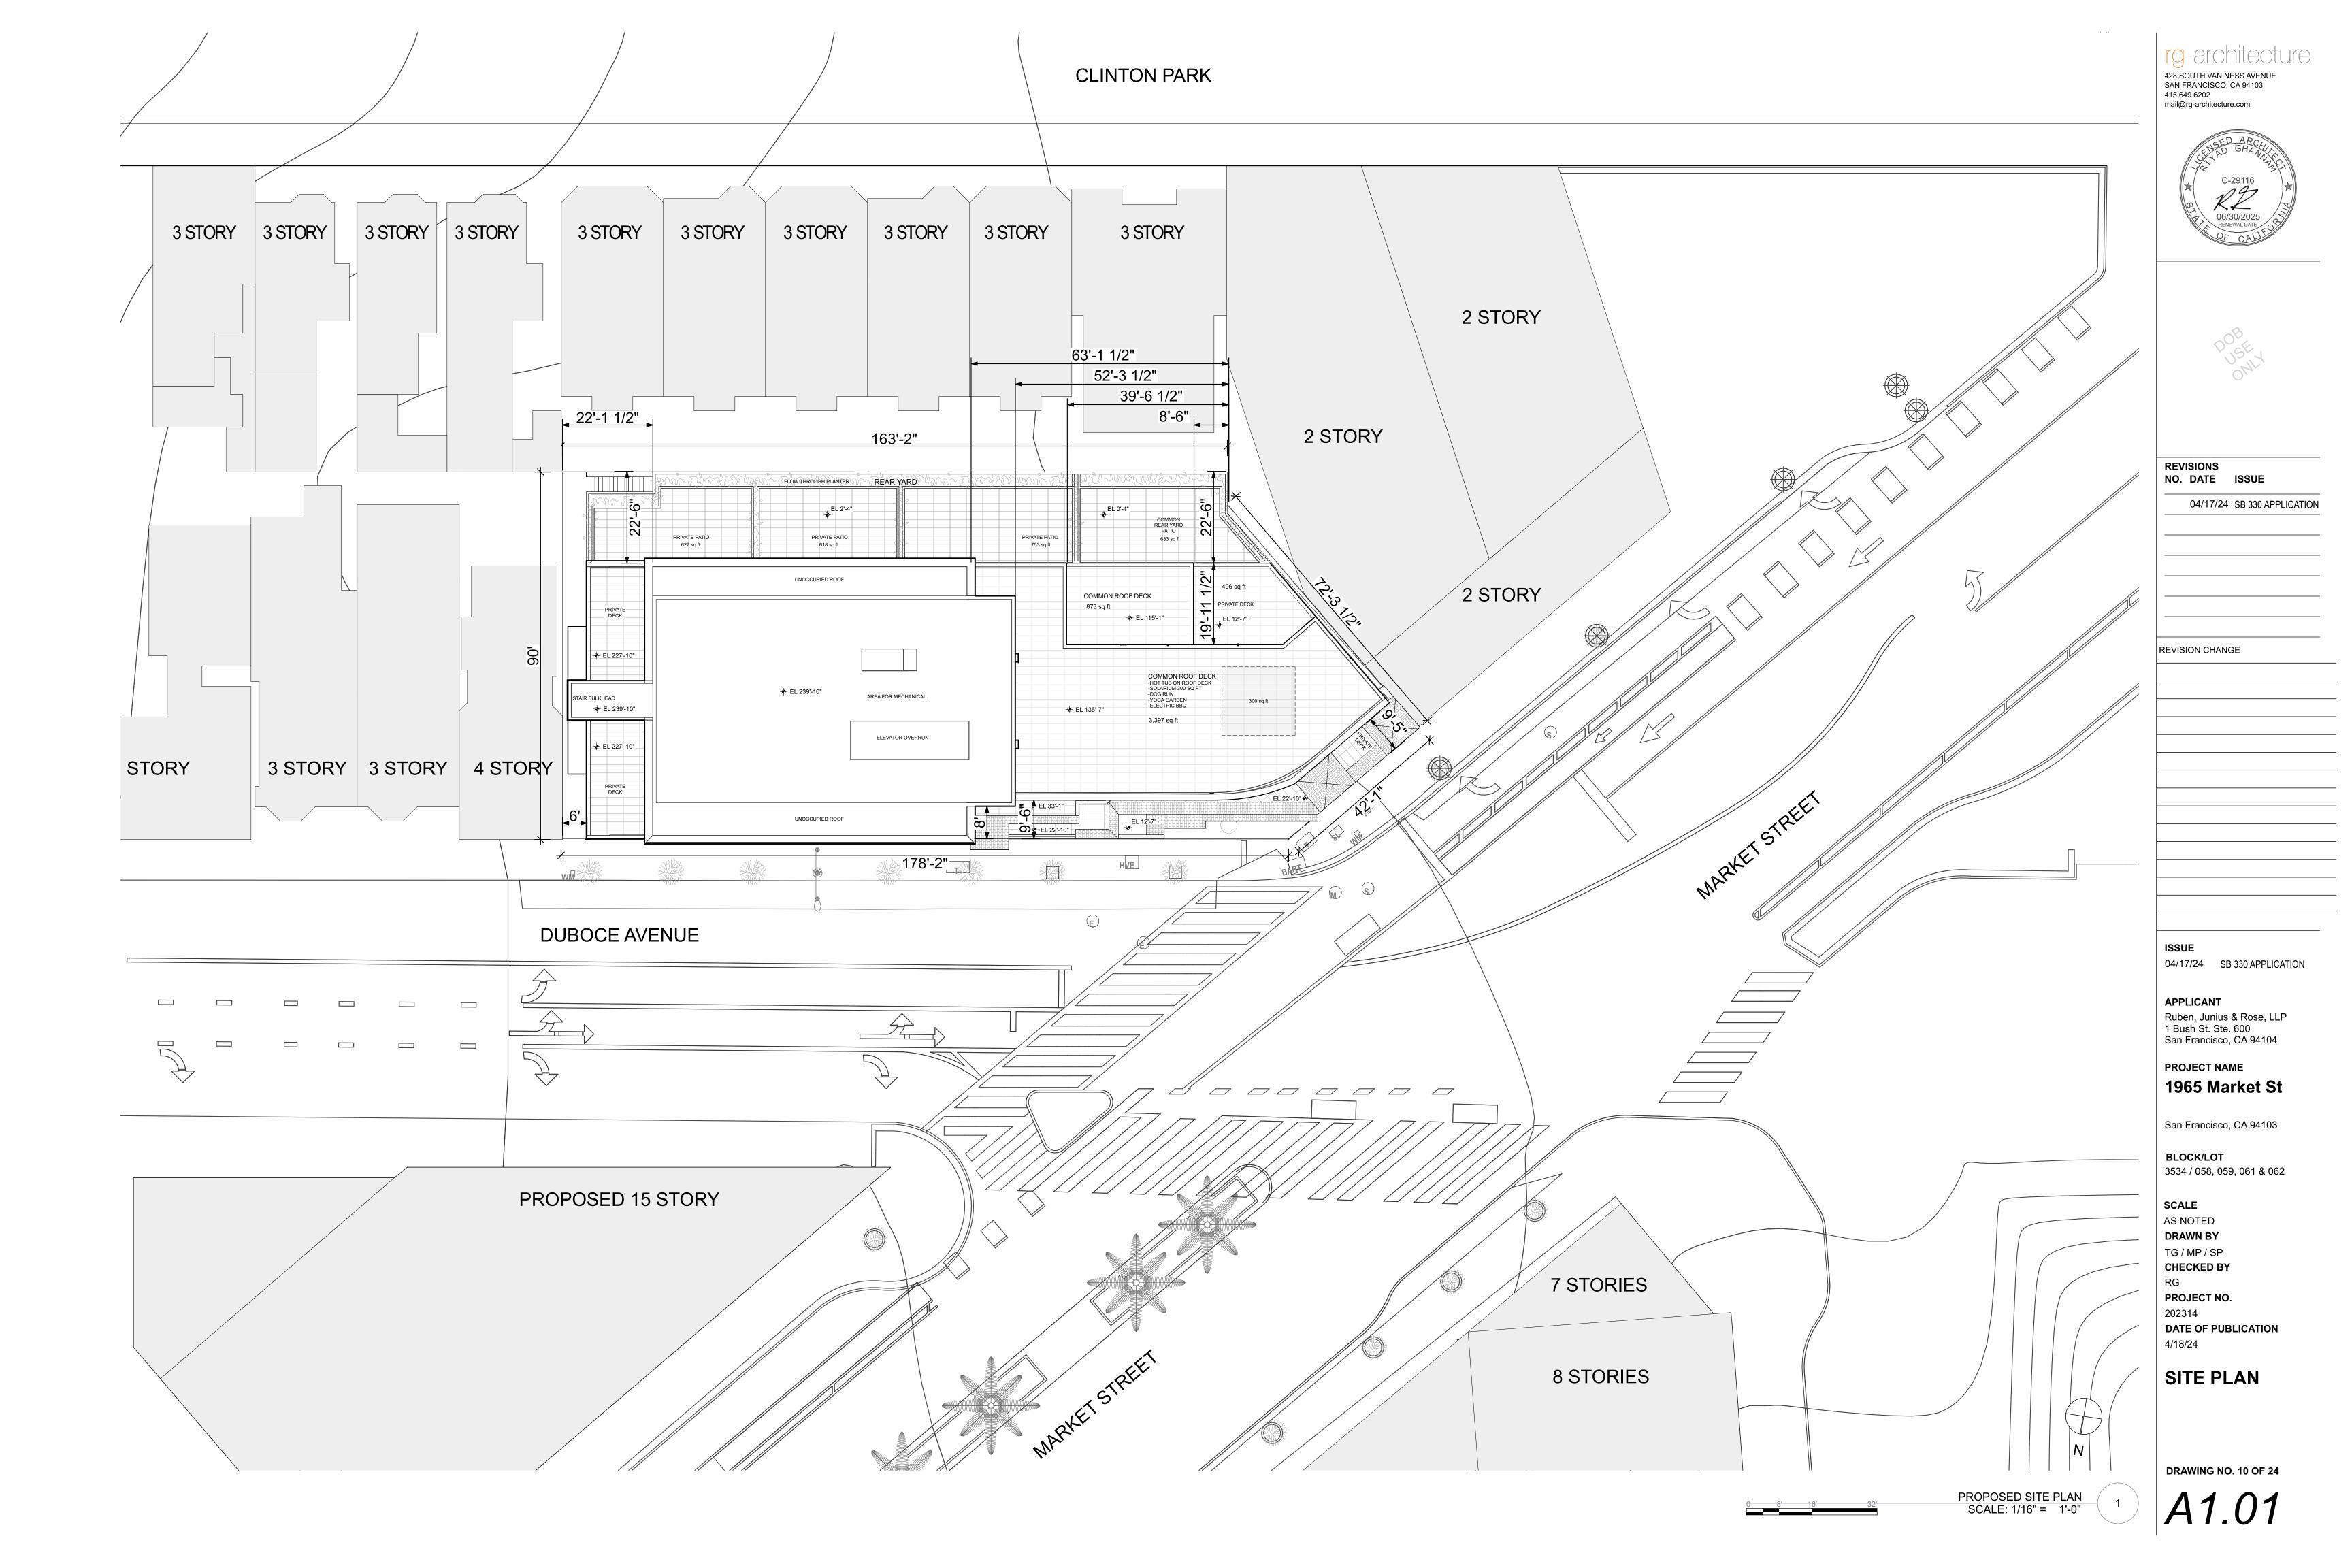
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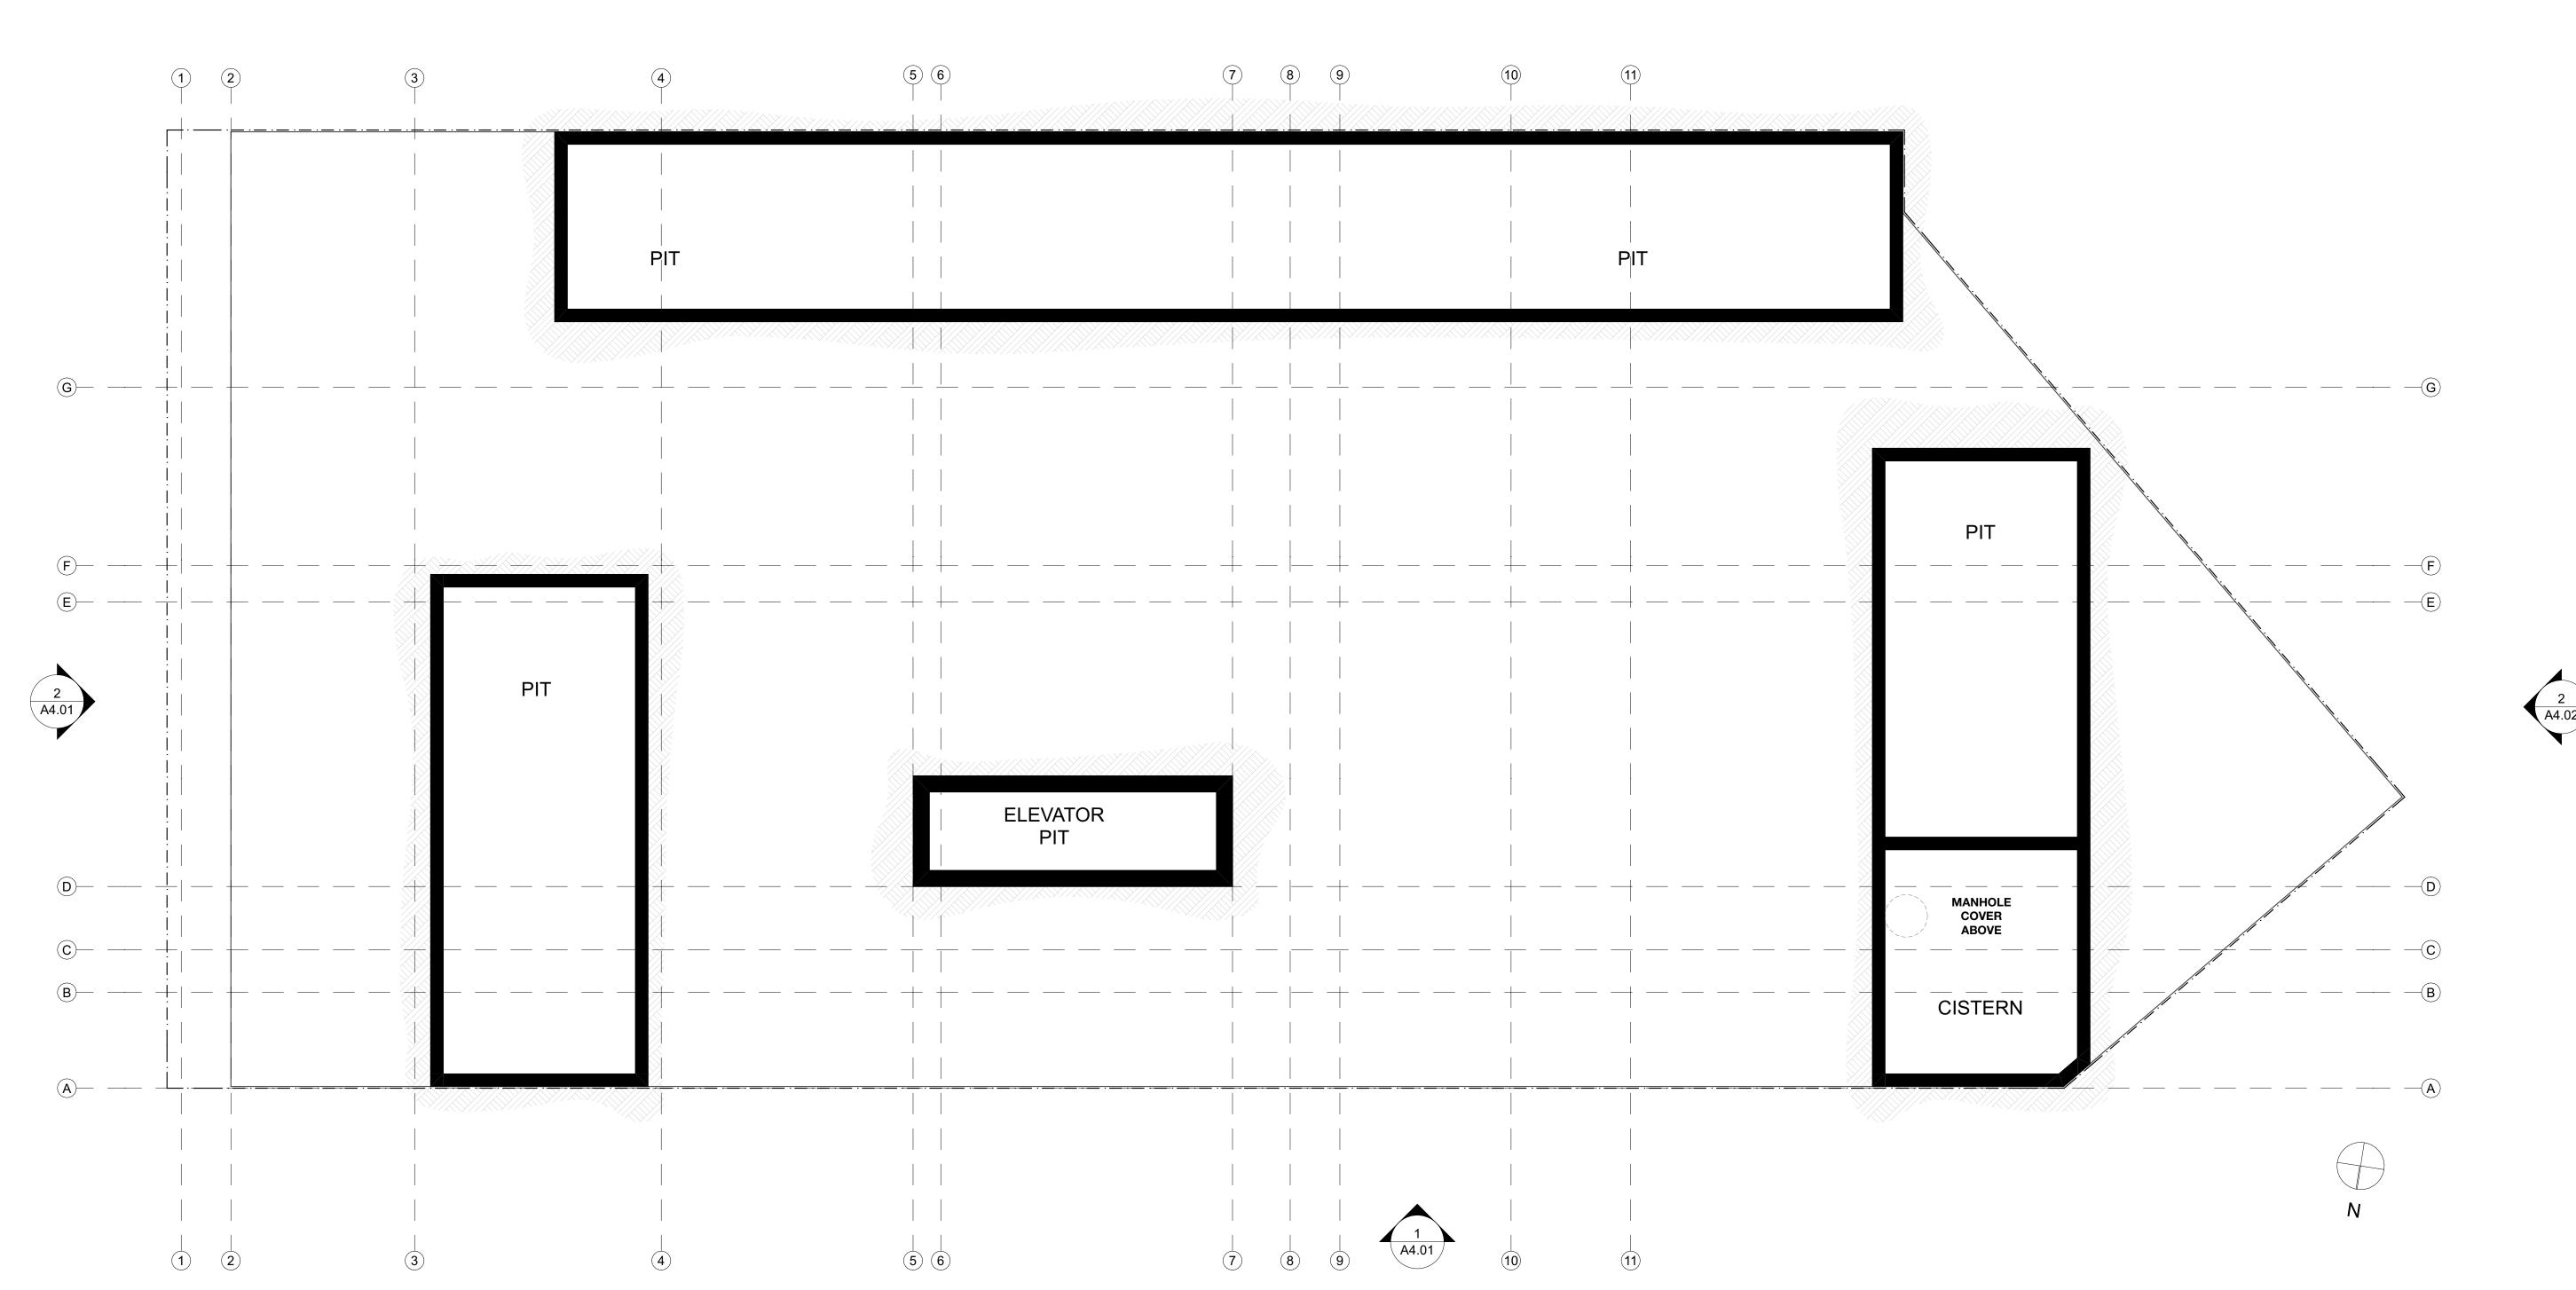
RENDERINGS

DRAWING NO. 8 OF 24







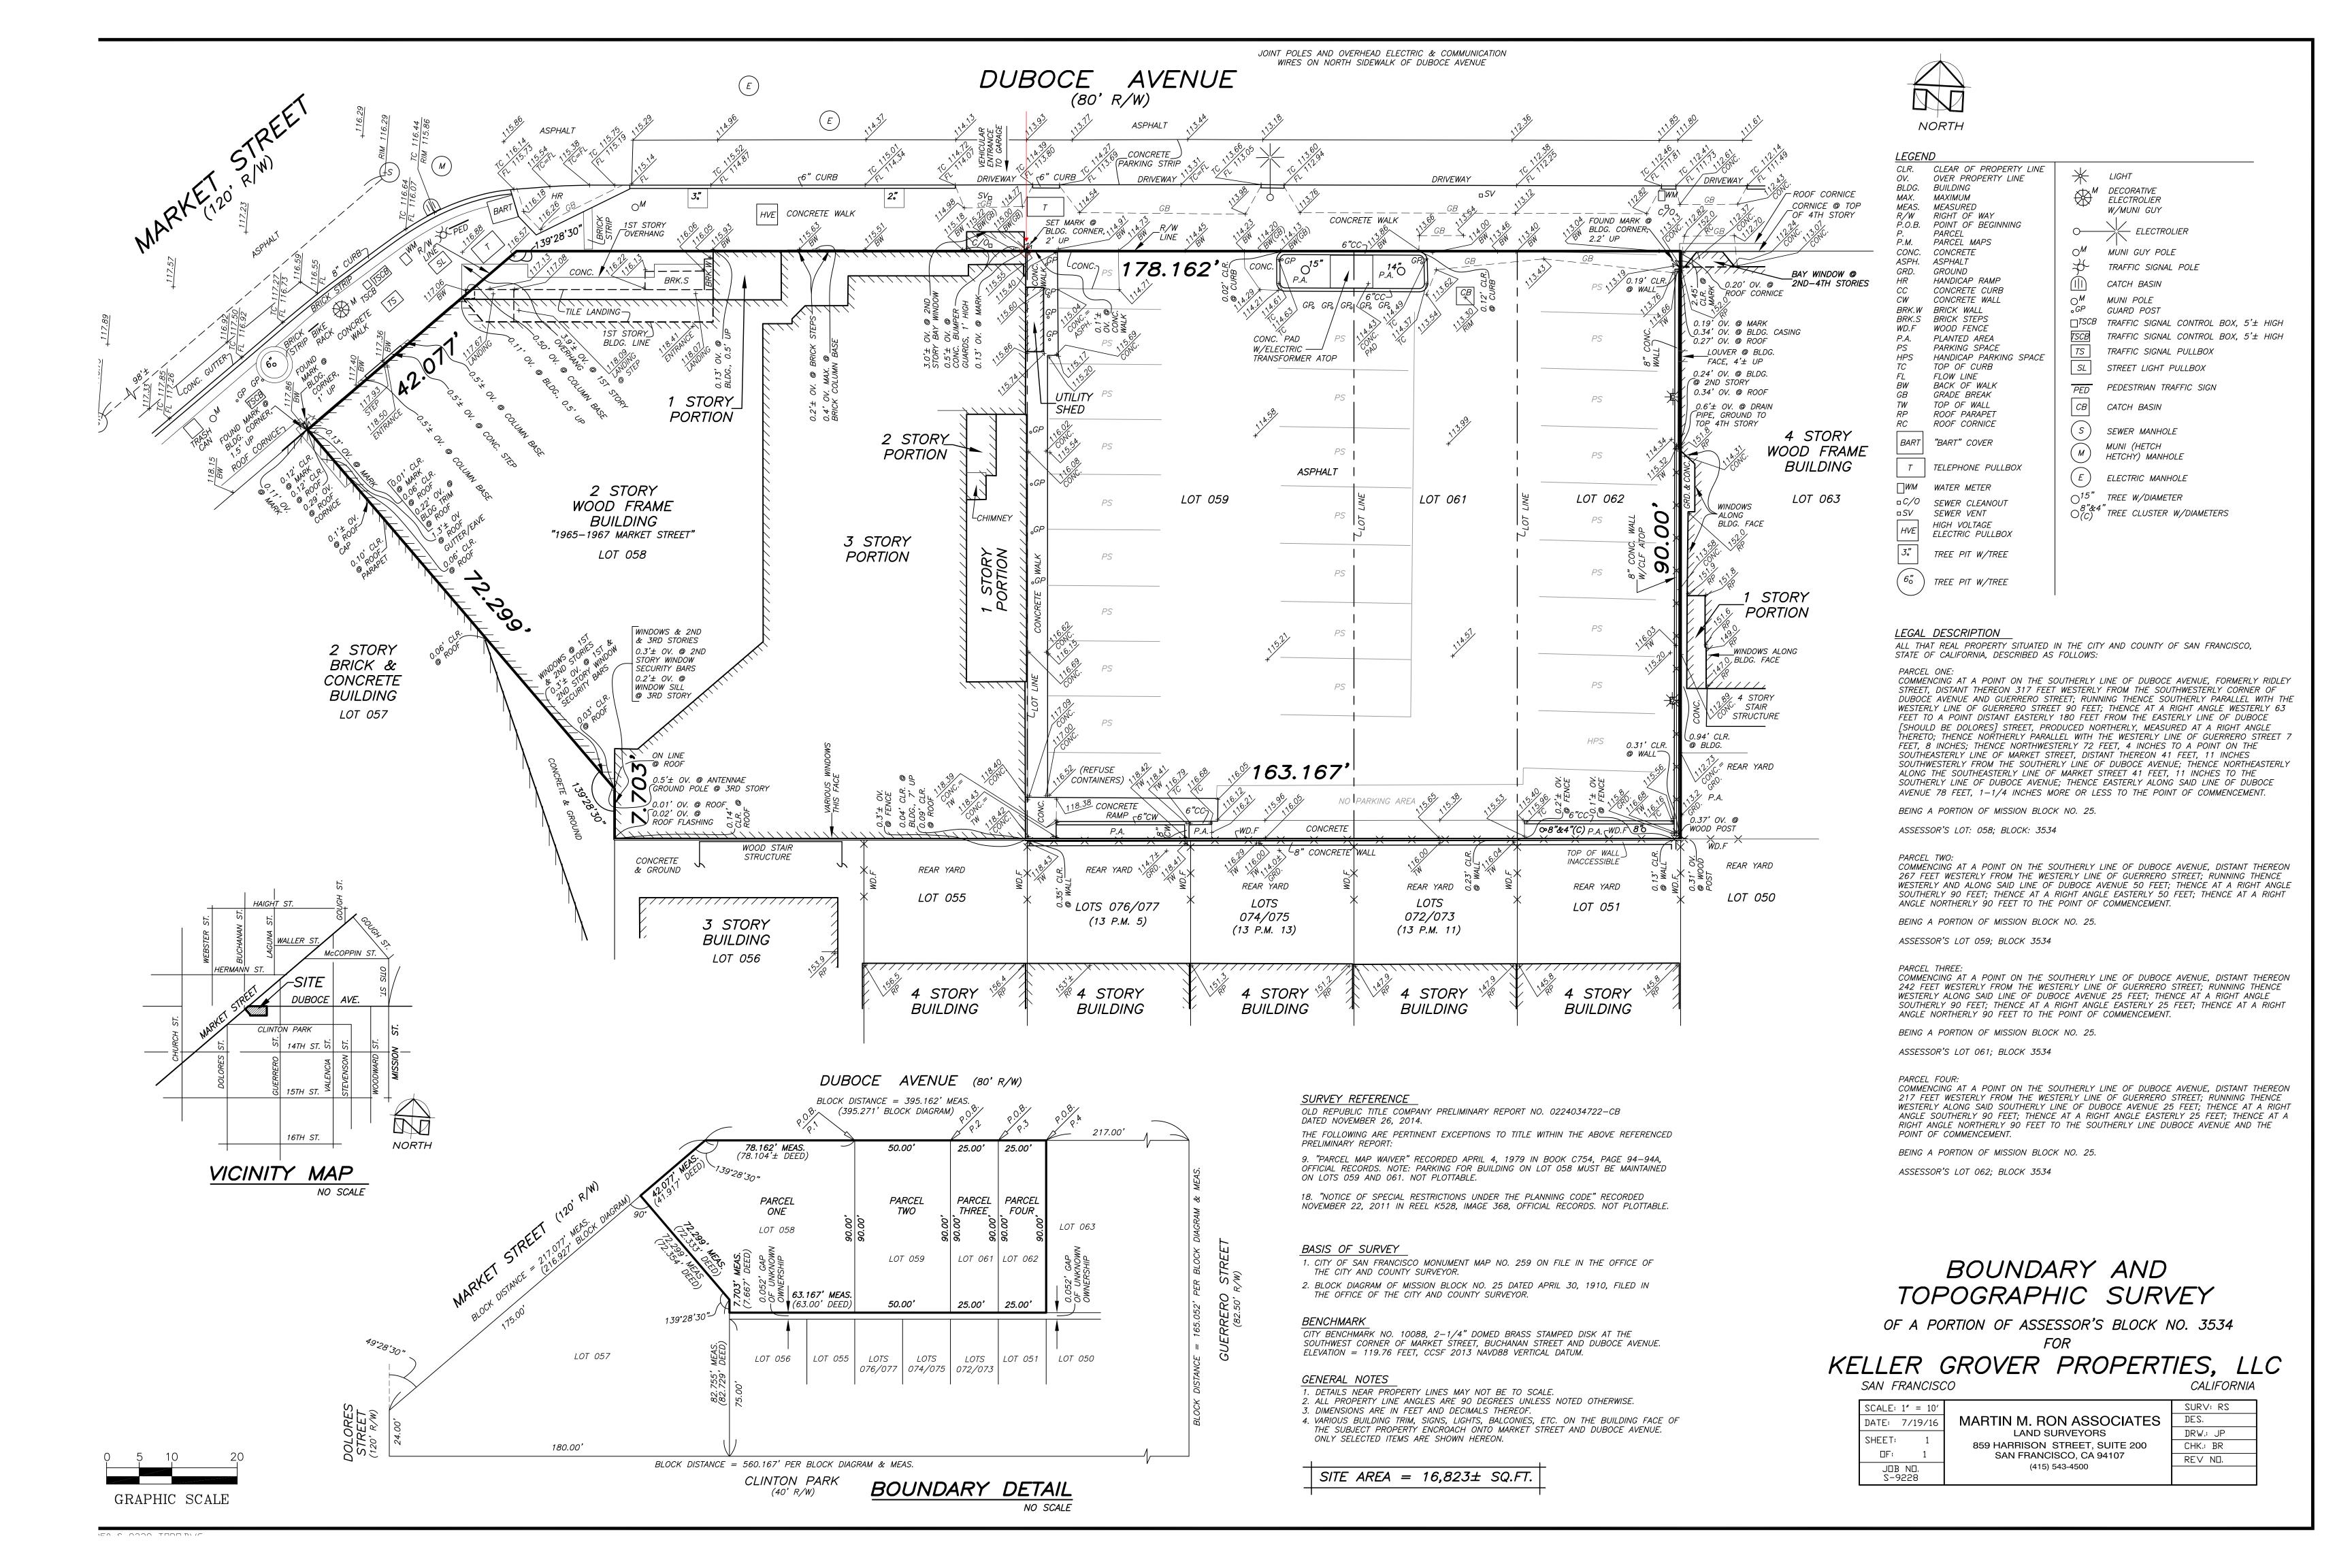





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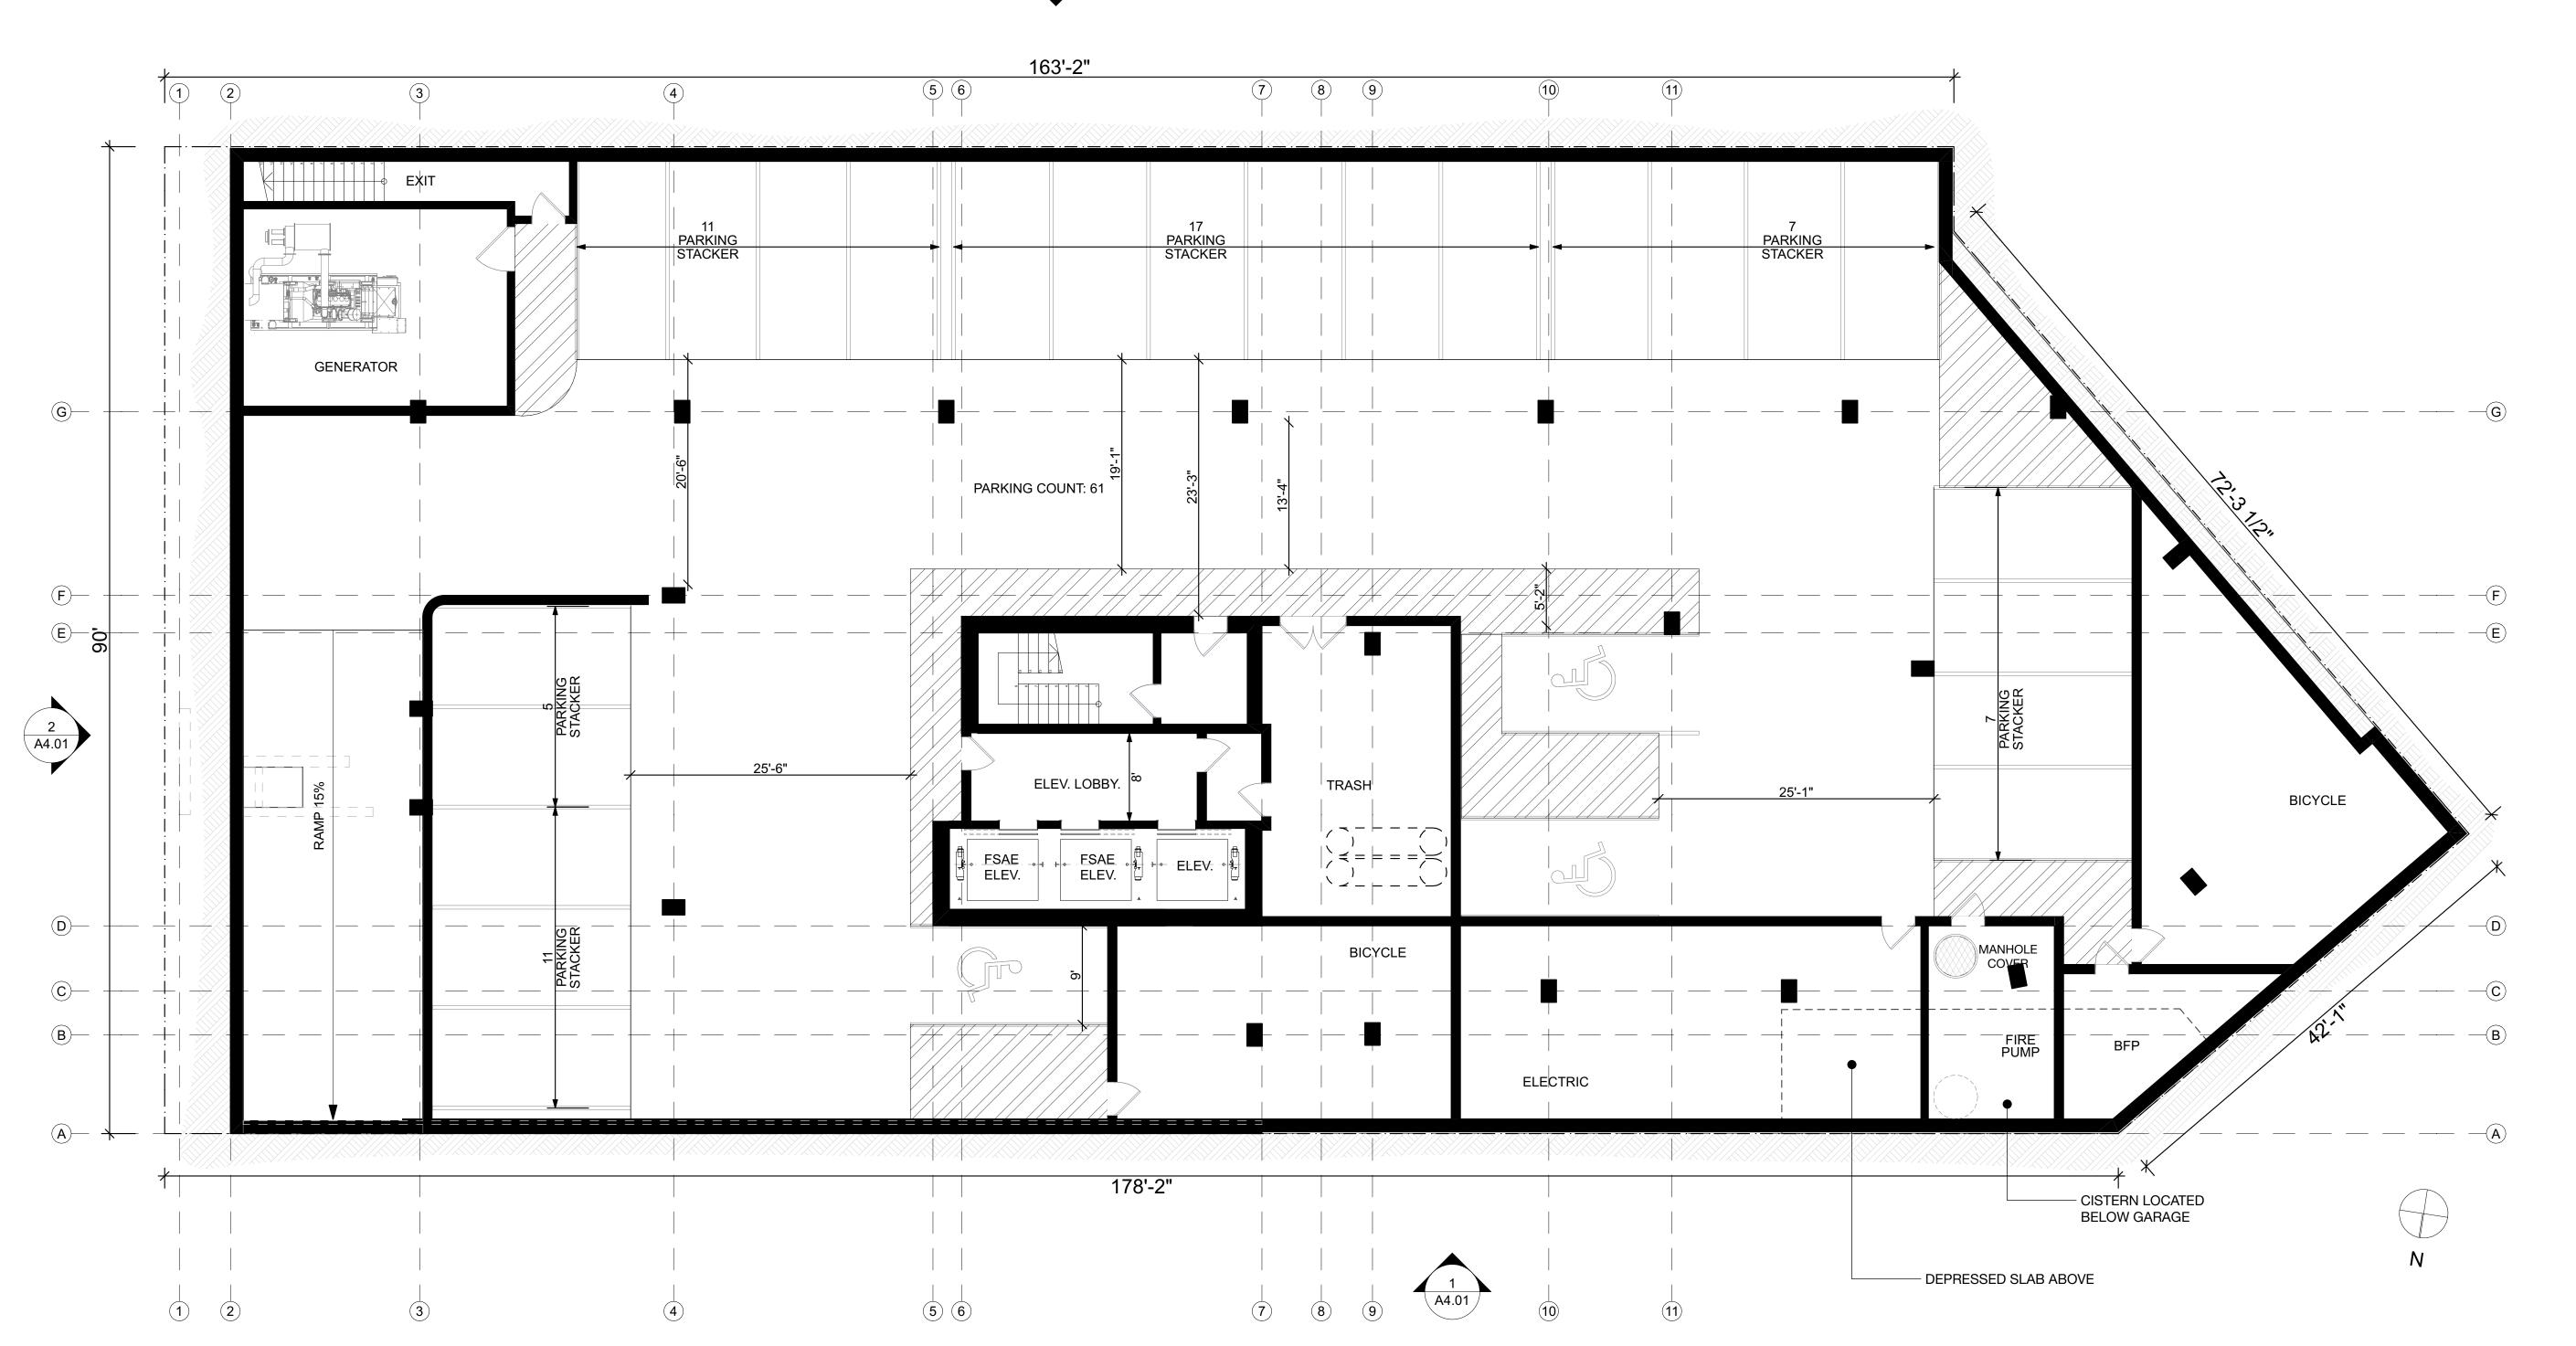
CISTERN SCALE: 1/8" = 1'-0"

SCALE AS NOTED

CISTERN/PIT

DRAWING NO. 11 OF 24





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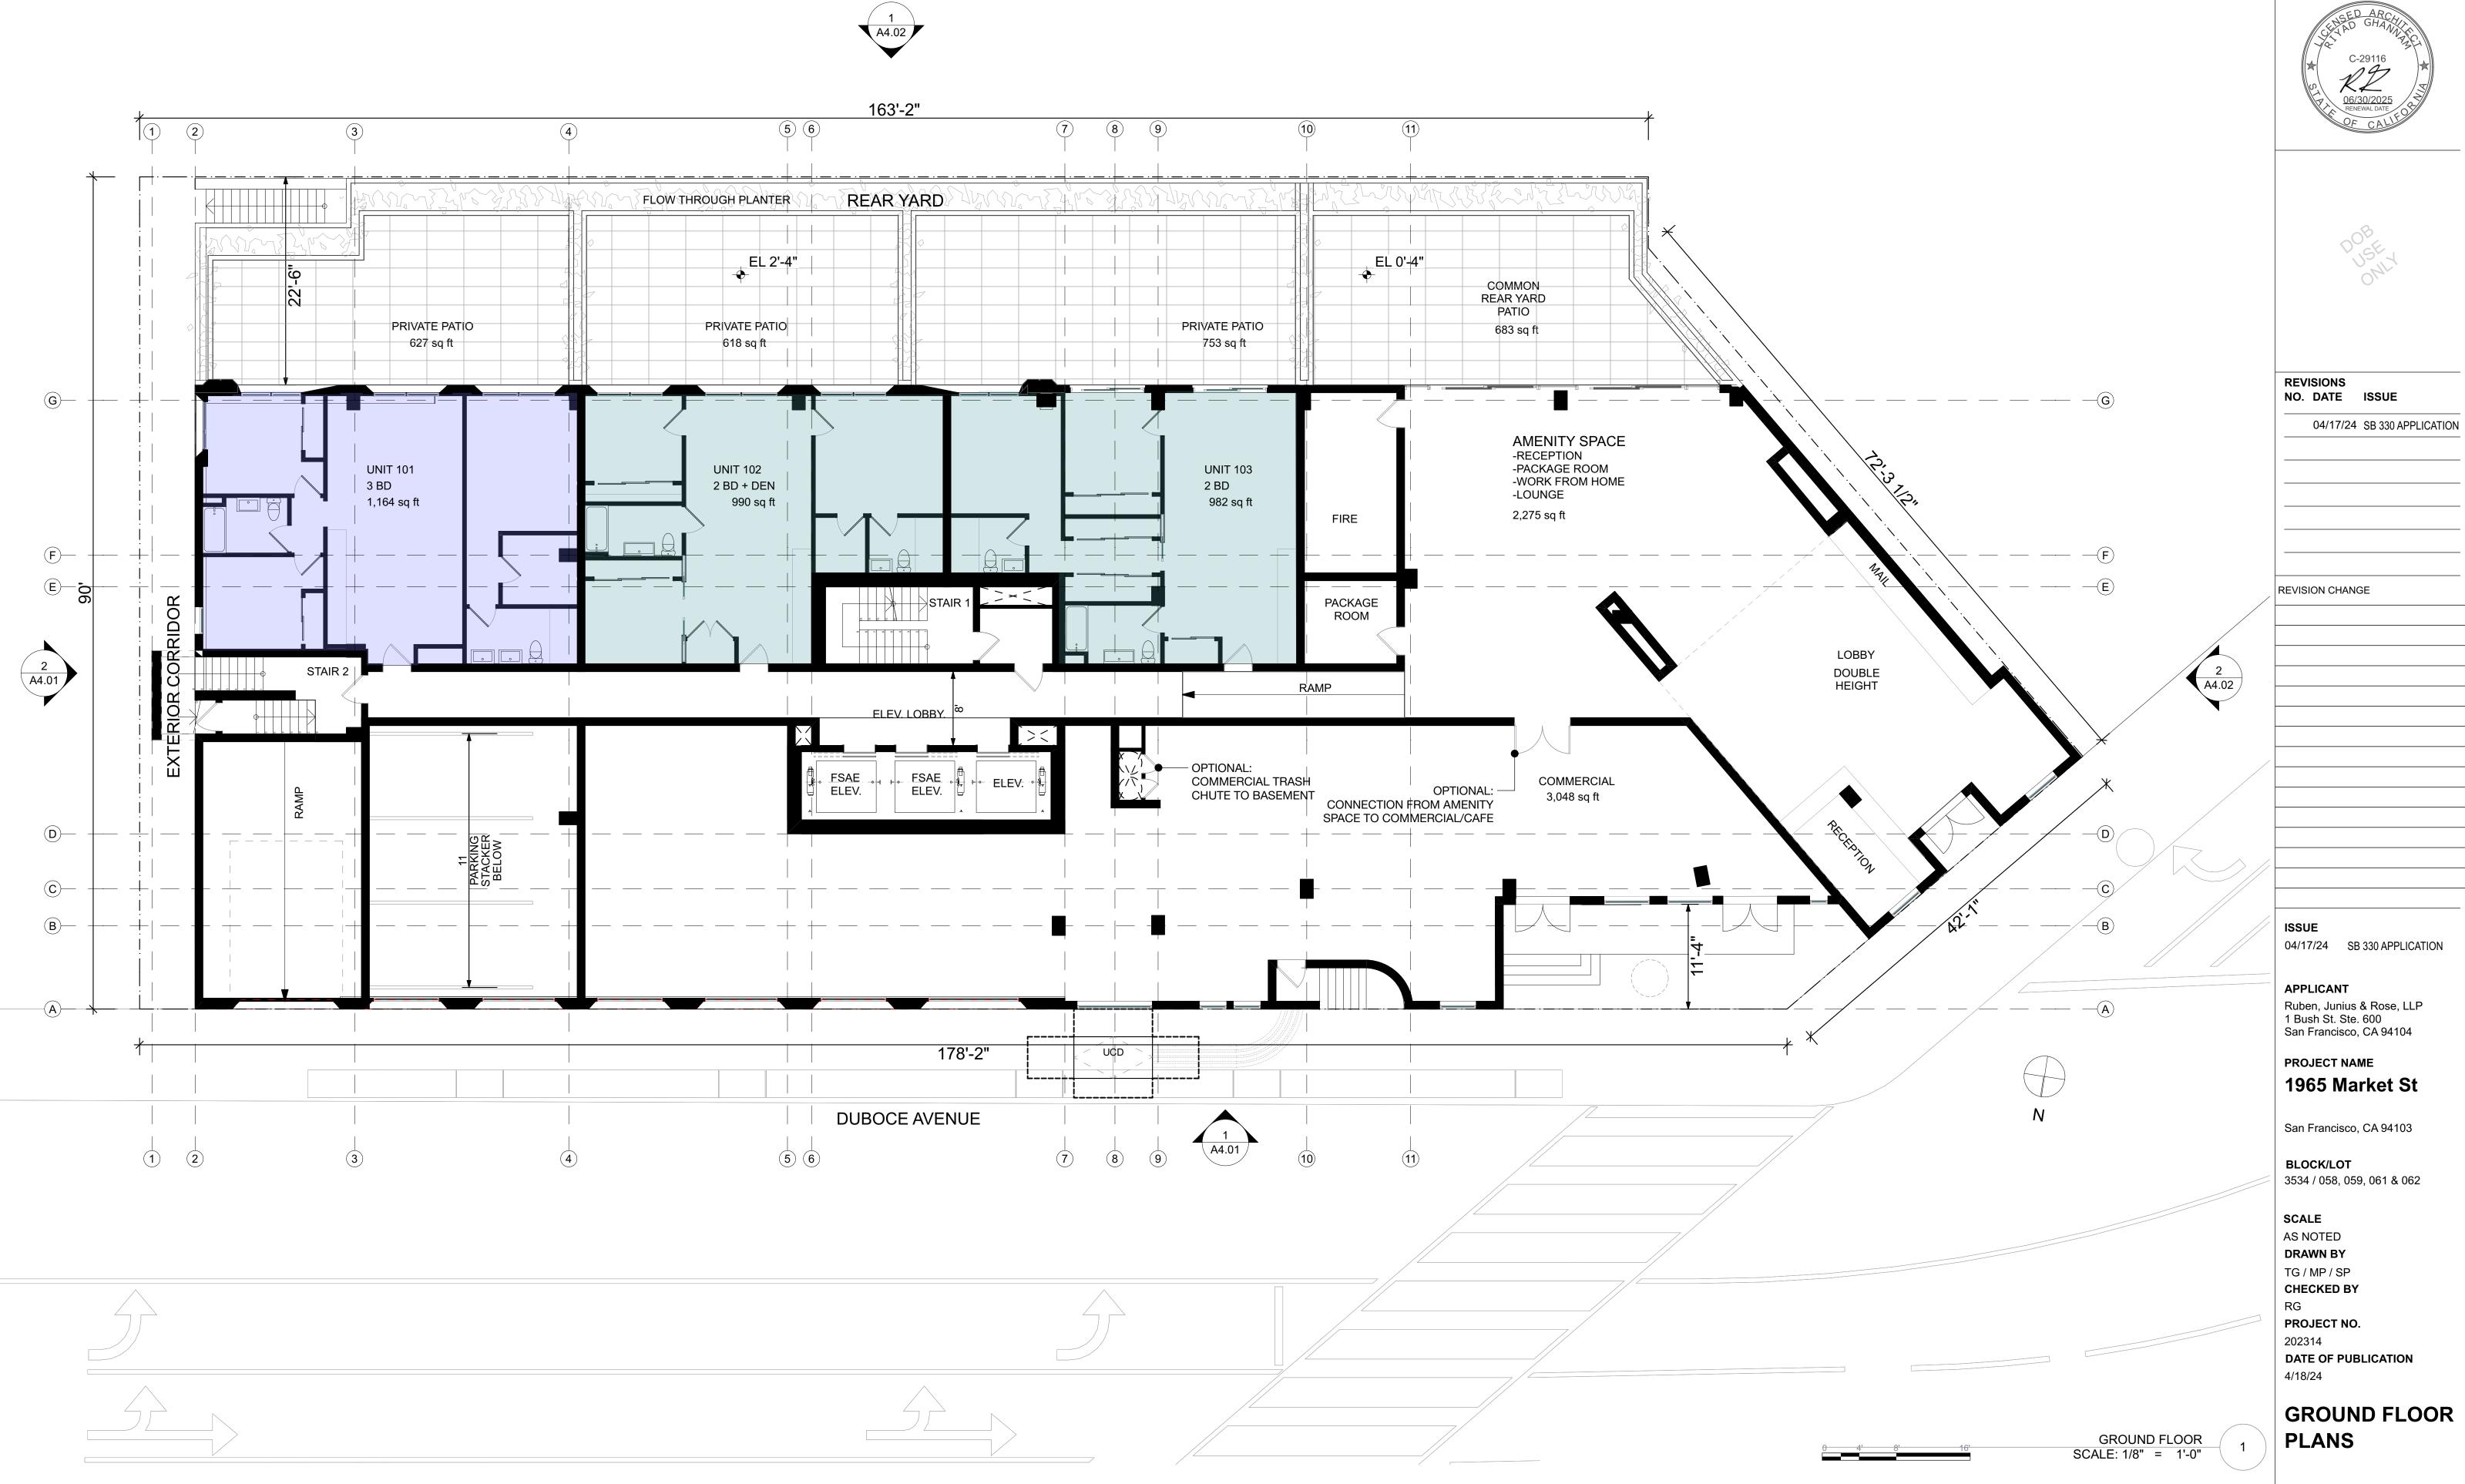
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4/18/24

BASEMENT SCALE: 1/8" = 1'-0" BASEMENT

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BLOCK/LOT

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GROUND FLOOR

DRAWING NO. 13 OF 24





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2ND FLOOR

DRAWING NO. 14 OF 24

2ND STORY SCALE: 1/8" = 1'-0"





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3RD FLOOR

3RD STORY SCALE: 1/8" = 1'-0"

DRAWING NO. 15 OF 24

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4TH FLOOR

DRAWING NO. 16 OF 24

4TH STORY SCALE: 1/8" = 1'-0"









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5TH TO 11TH **FLOOR**

DRAWING NO. 17 OF 24

5TH TO 11TH FLOOR SCALE: 1/8" = 1'-0"





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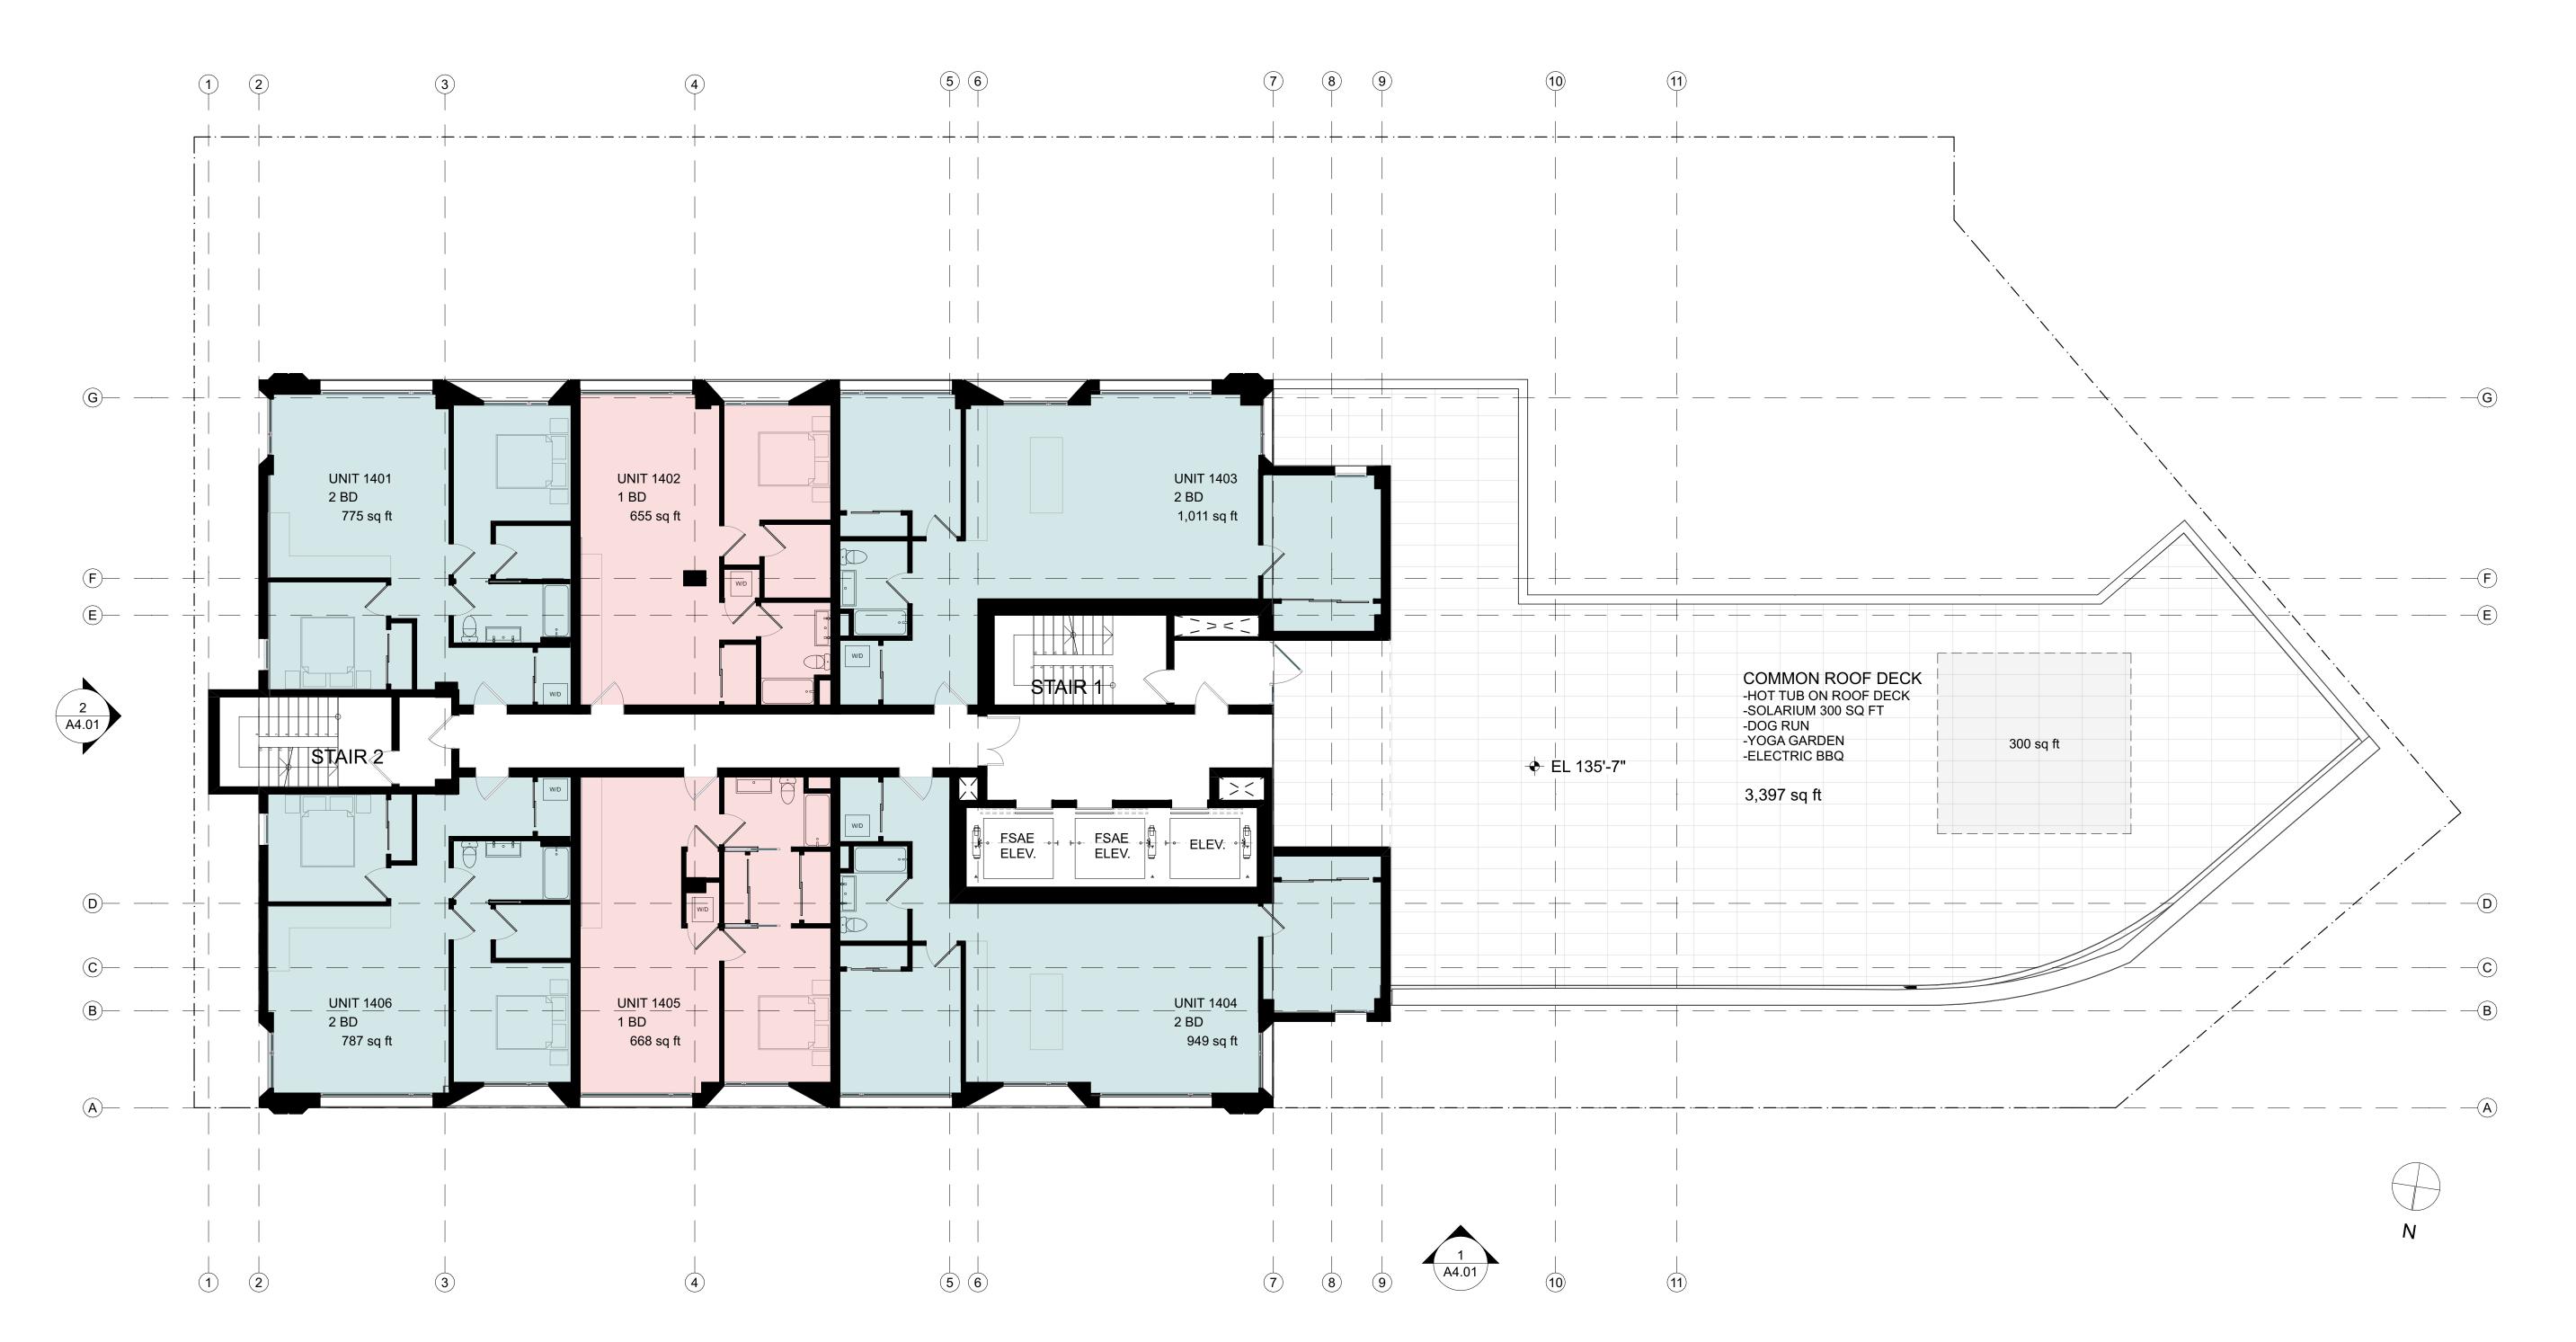
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12TH TO 13TH FLOOR SCALE: 1/8" = 1'-0" 12TH to 13TH FLOOR FLOOR

DRAWING NO. 18 OF 24









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4/18/24 14TH FLOOR

DRAWING NO. 19 OF 24

14TH FLOOR SCALE: 1/8" = 1'-0"









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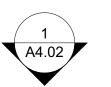
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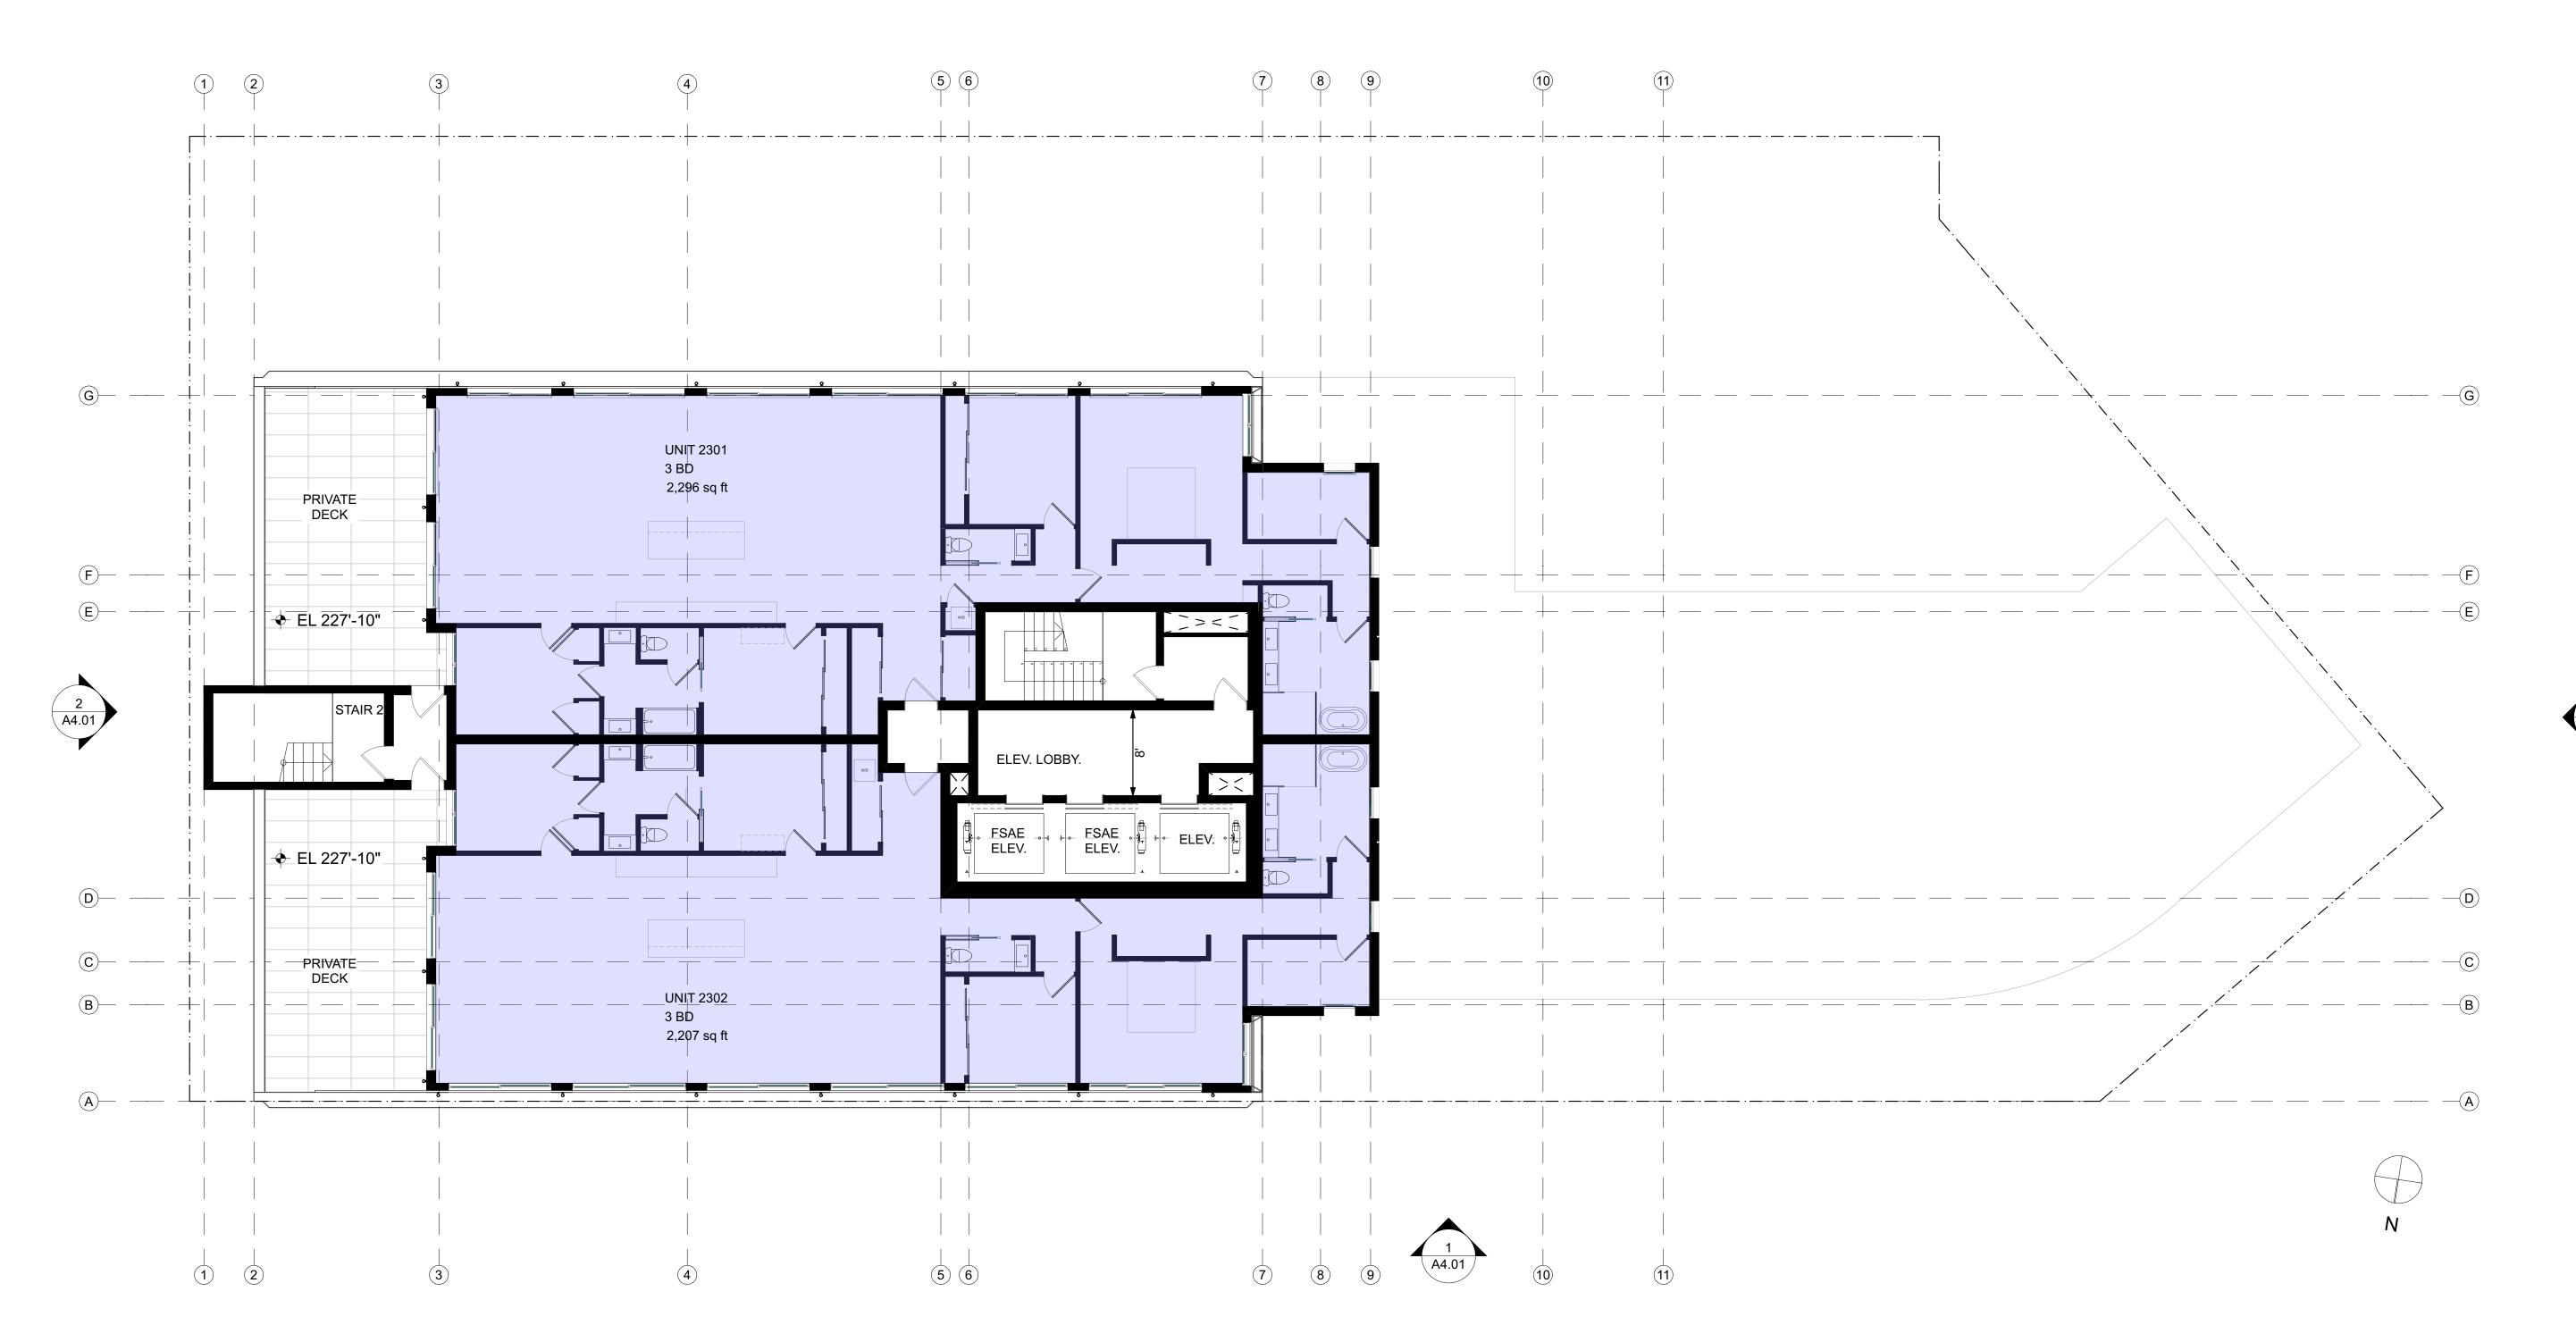
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15TH TO 21ND FLOOR SCALE: 1/8" = 1'-0"

15TH TO 22ND FLOOR

DRAWING NO. 20 OF 24





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San Francisco, CA 94103

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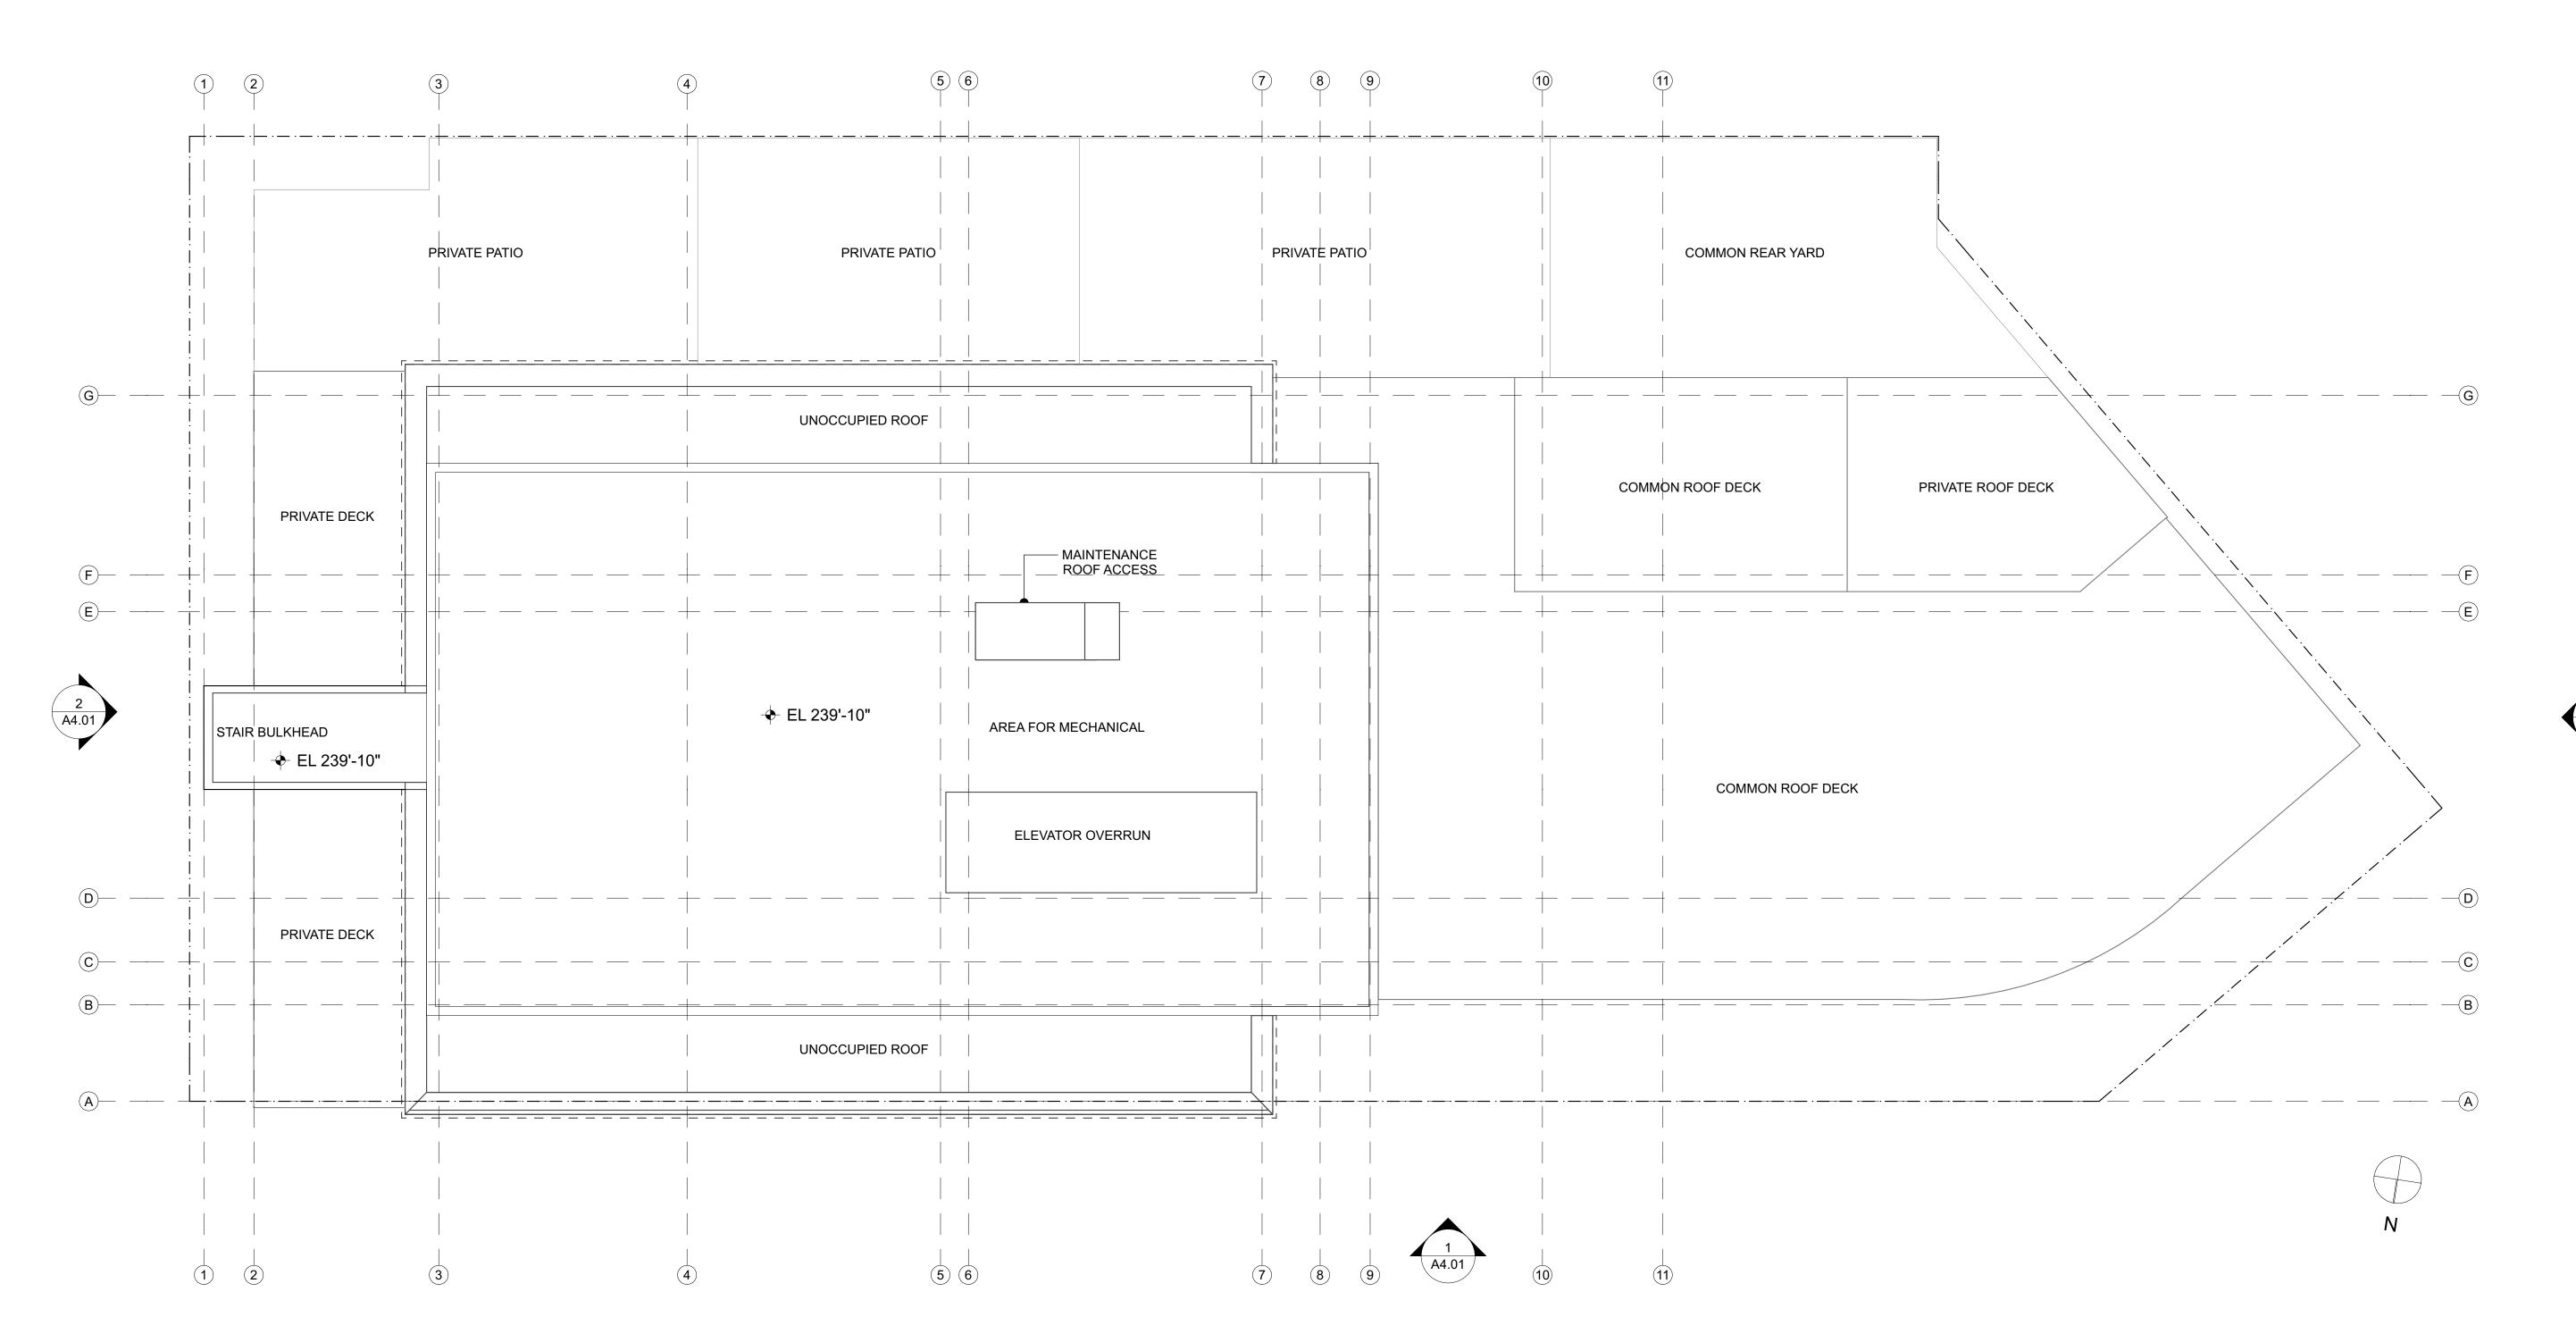
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23RD FLOOR/ PENTHOUSE

DRAWING NO. 21 OF 24

23 FLOOR/PENTHOUSE SCALE: 1/8" = 1'-0"









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PROJECT NAME

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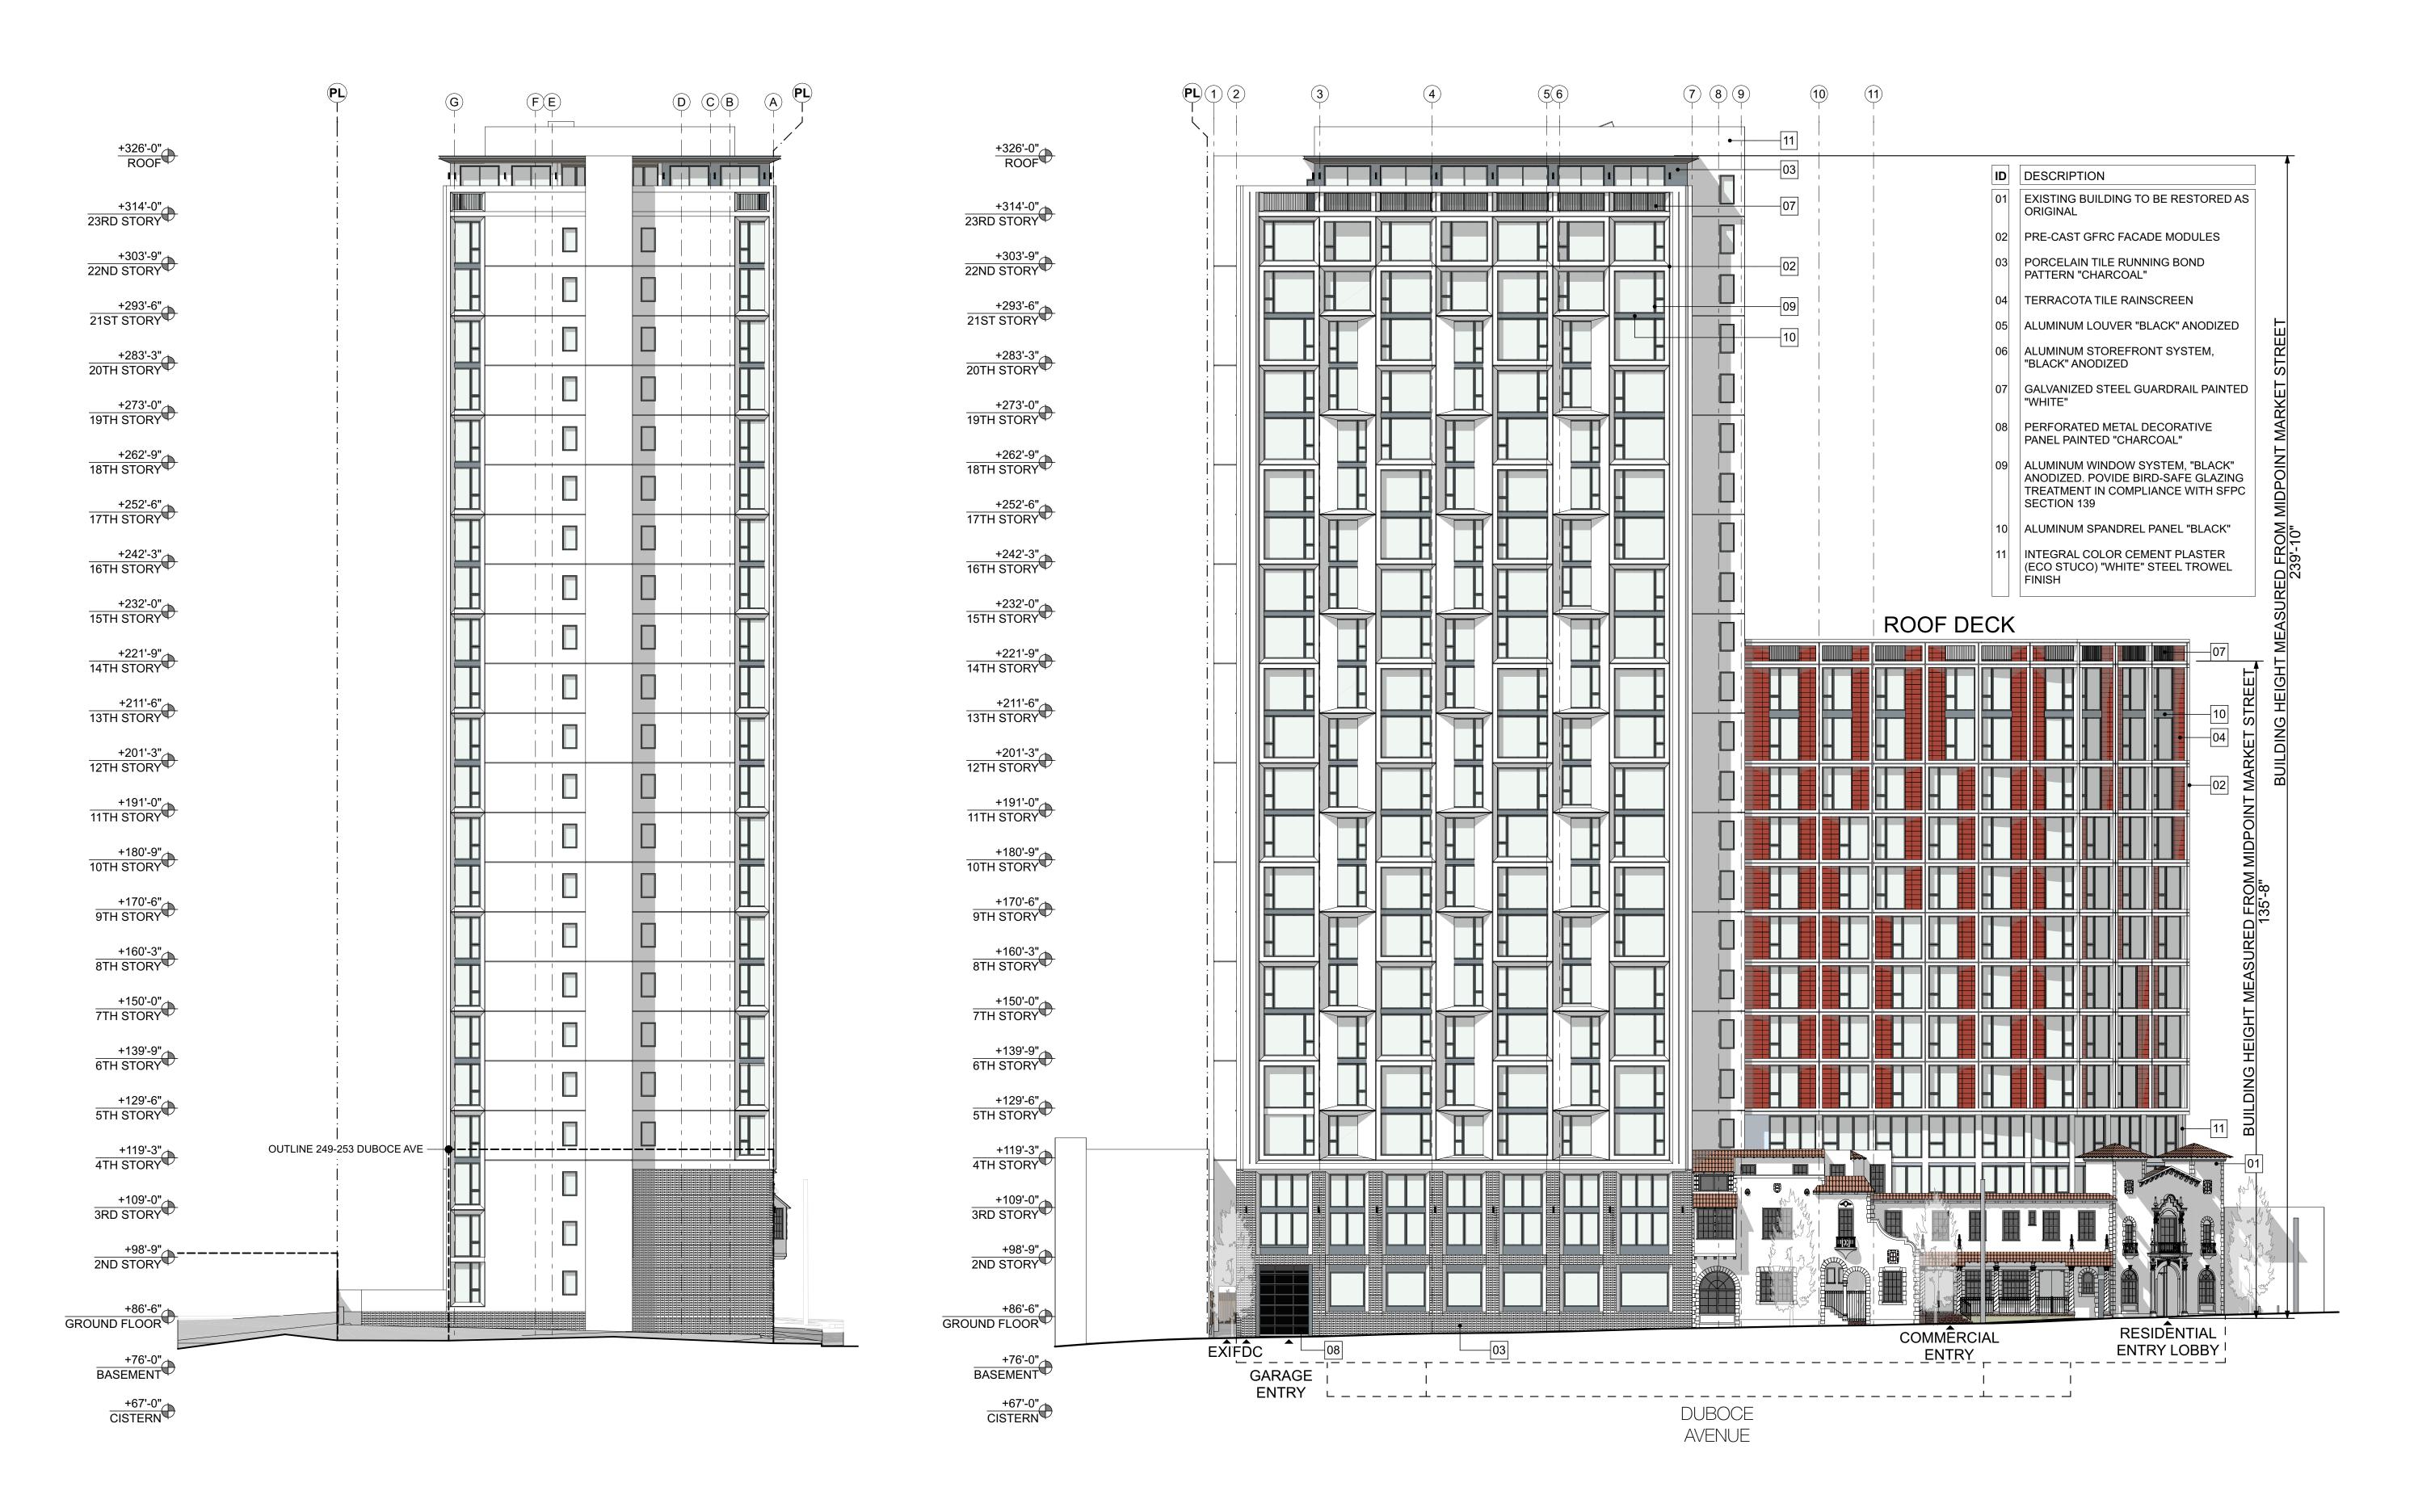
SCALE AS NOTED

DATE OF PUBLICATION 4/18/24

ROOF

ROOF SCALE: 1/8" = 1'-0"

DRAWING NO. 22 OF 24



EAST ELEVATION

NORTH ELEVATION AT DUBOCE

428 SOUTH VAN NESS AVENUE SAN FRANCISCO, CA 94103 415.649.6202 mail@rg-architecture.com





LICATION

ISSUE
04/17/24 SB 330 APPLICATION

APPLICANT
Ruben, Junius & Rose, LLP
1 Bush St. Ste. 600
San Francisco, CA 94104

PROJECT NAME

1965 Market St

San Francisco, CA 94103

BLOCK/LOT 3534 / 058, 059, 061 & 062

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PROJECT NO.

SCALE

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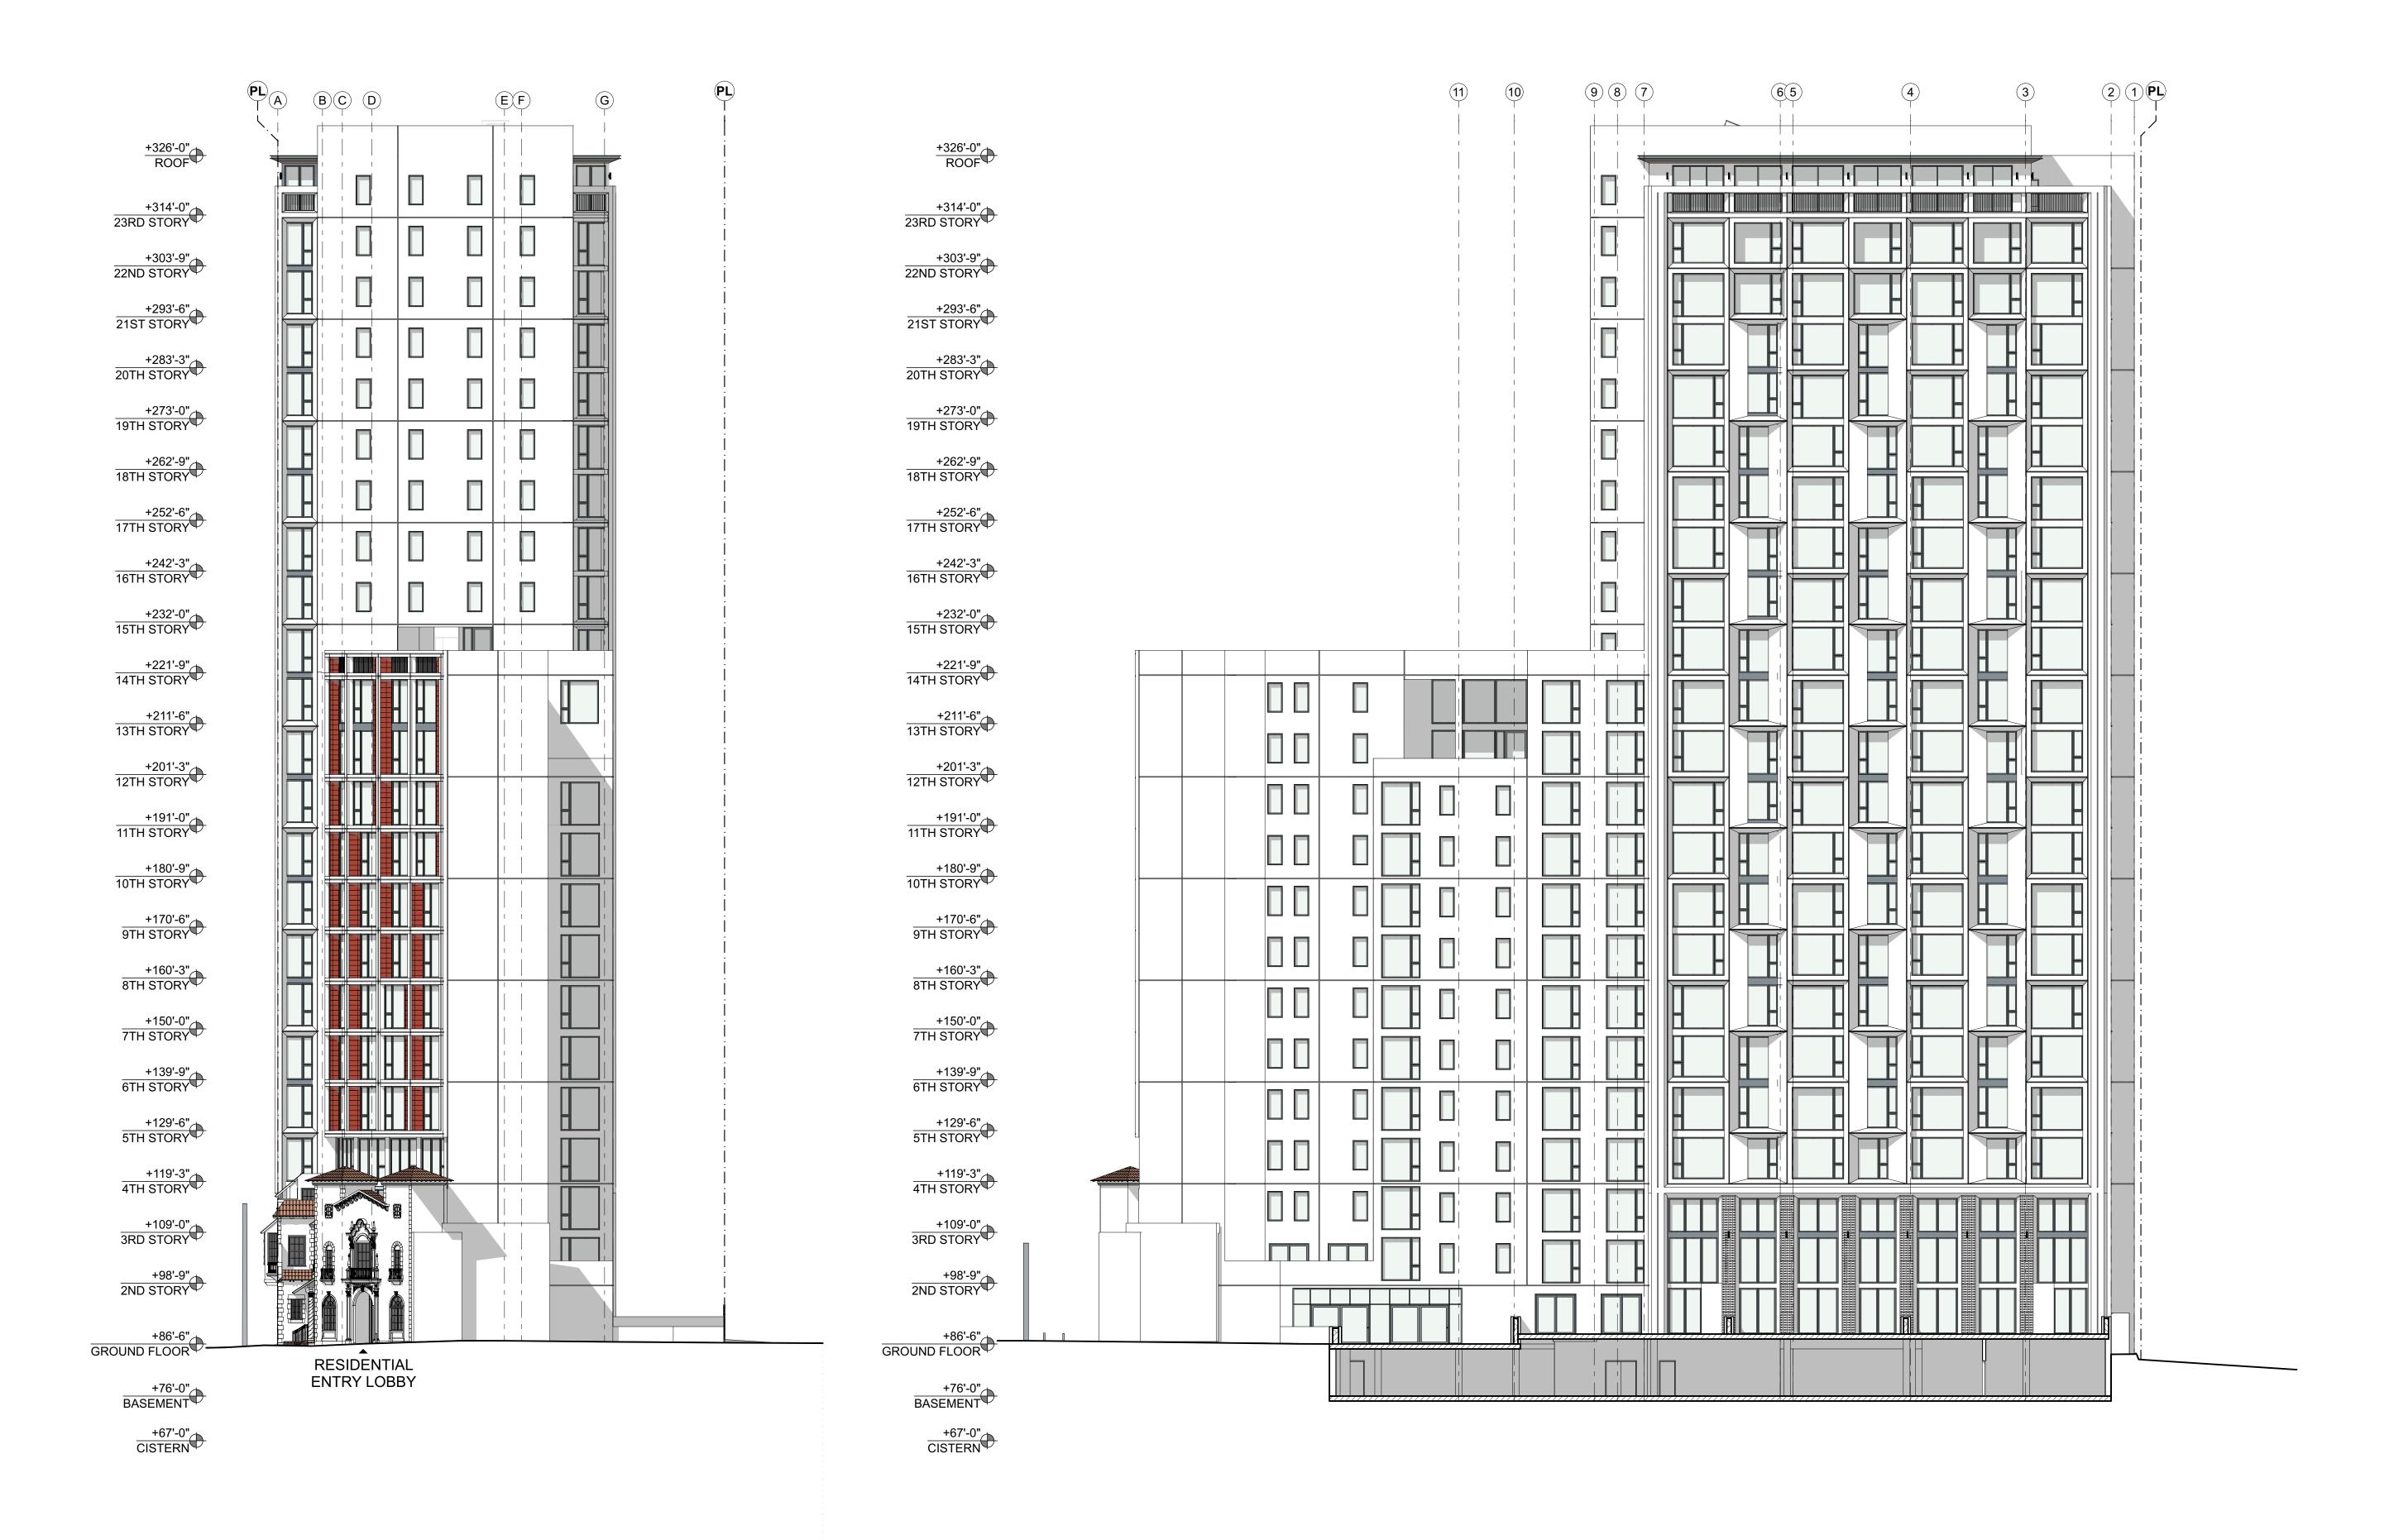
RG **PROJECT NO.** 202314

202314 **DATE OF PUBLICATION**4/18/24

ELEVATION

DRAWING NO. 23 OF 24

A4.01



WEST ELEVATION

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ELEVATION

SOUTH ELEVATION

DRAWING NO. 24 OF 24

A4.02